



# CONSTRUCTION DRAWINGS

## BUFFALO RIVER AOC CAPPING AND HABITAT RESTORATION

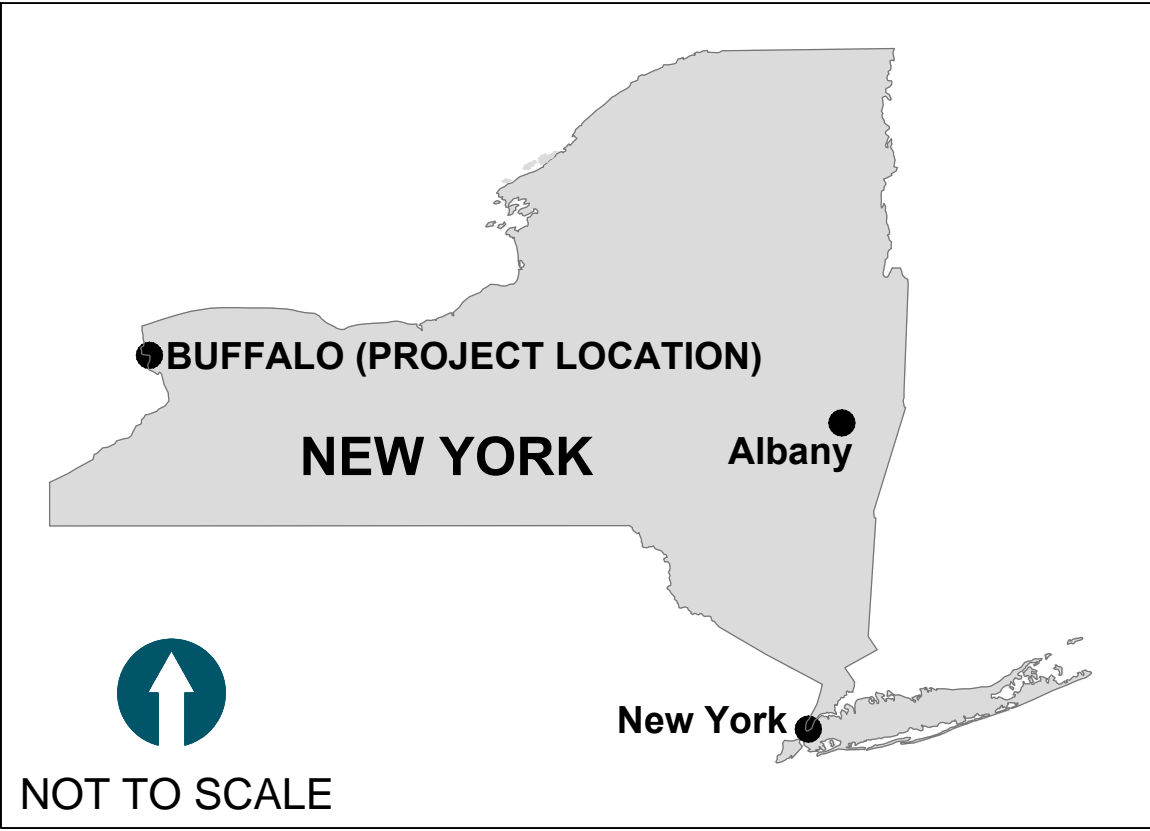

### SHEET LIST

SHEET NUMBER	SHEET NAME	SHEET TITLE
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03	G-02	STAGING LOCATION OPTIONS
04	C-01	EXISTING CONDITIONS - KATHERINE STREET PENINSULA
05	C-02	EXISTING CONDITIONS - CITY SHIP CANAL
06	C-03	EXISTING CONDITIONS - RIVERBEND (EAST)
07	C-04	EXISTING CONDITIONS - BUFFALO COLOR PENINSULA AND RIVERBEND (WEST)
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18	C-15	HABITAT RESTORATION PLAN VIEW - OHIO STREET SHORELINE
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21	C-18	CROSS-SECTIONS - ADM PILLSBURY
22	C-19	HABITAT RESTORATION DETAILS (1 OF 2)
23	C-20	HABITAT RESTORATION DETAILS (2 OF 2)

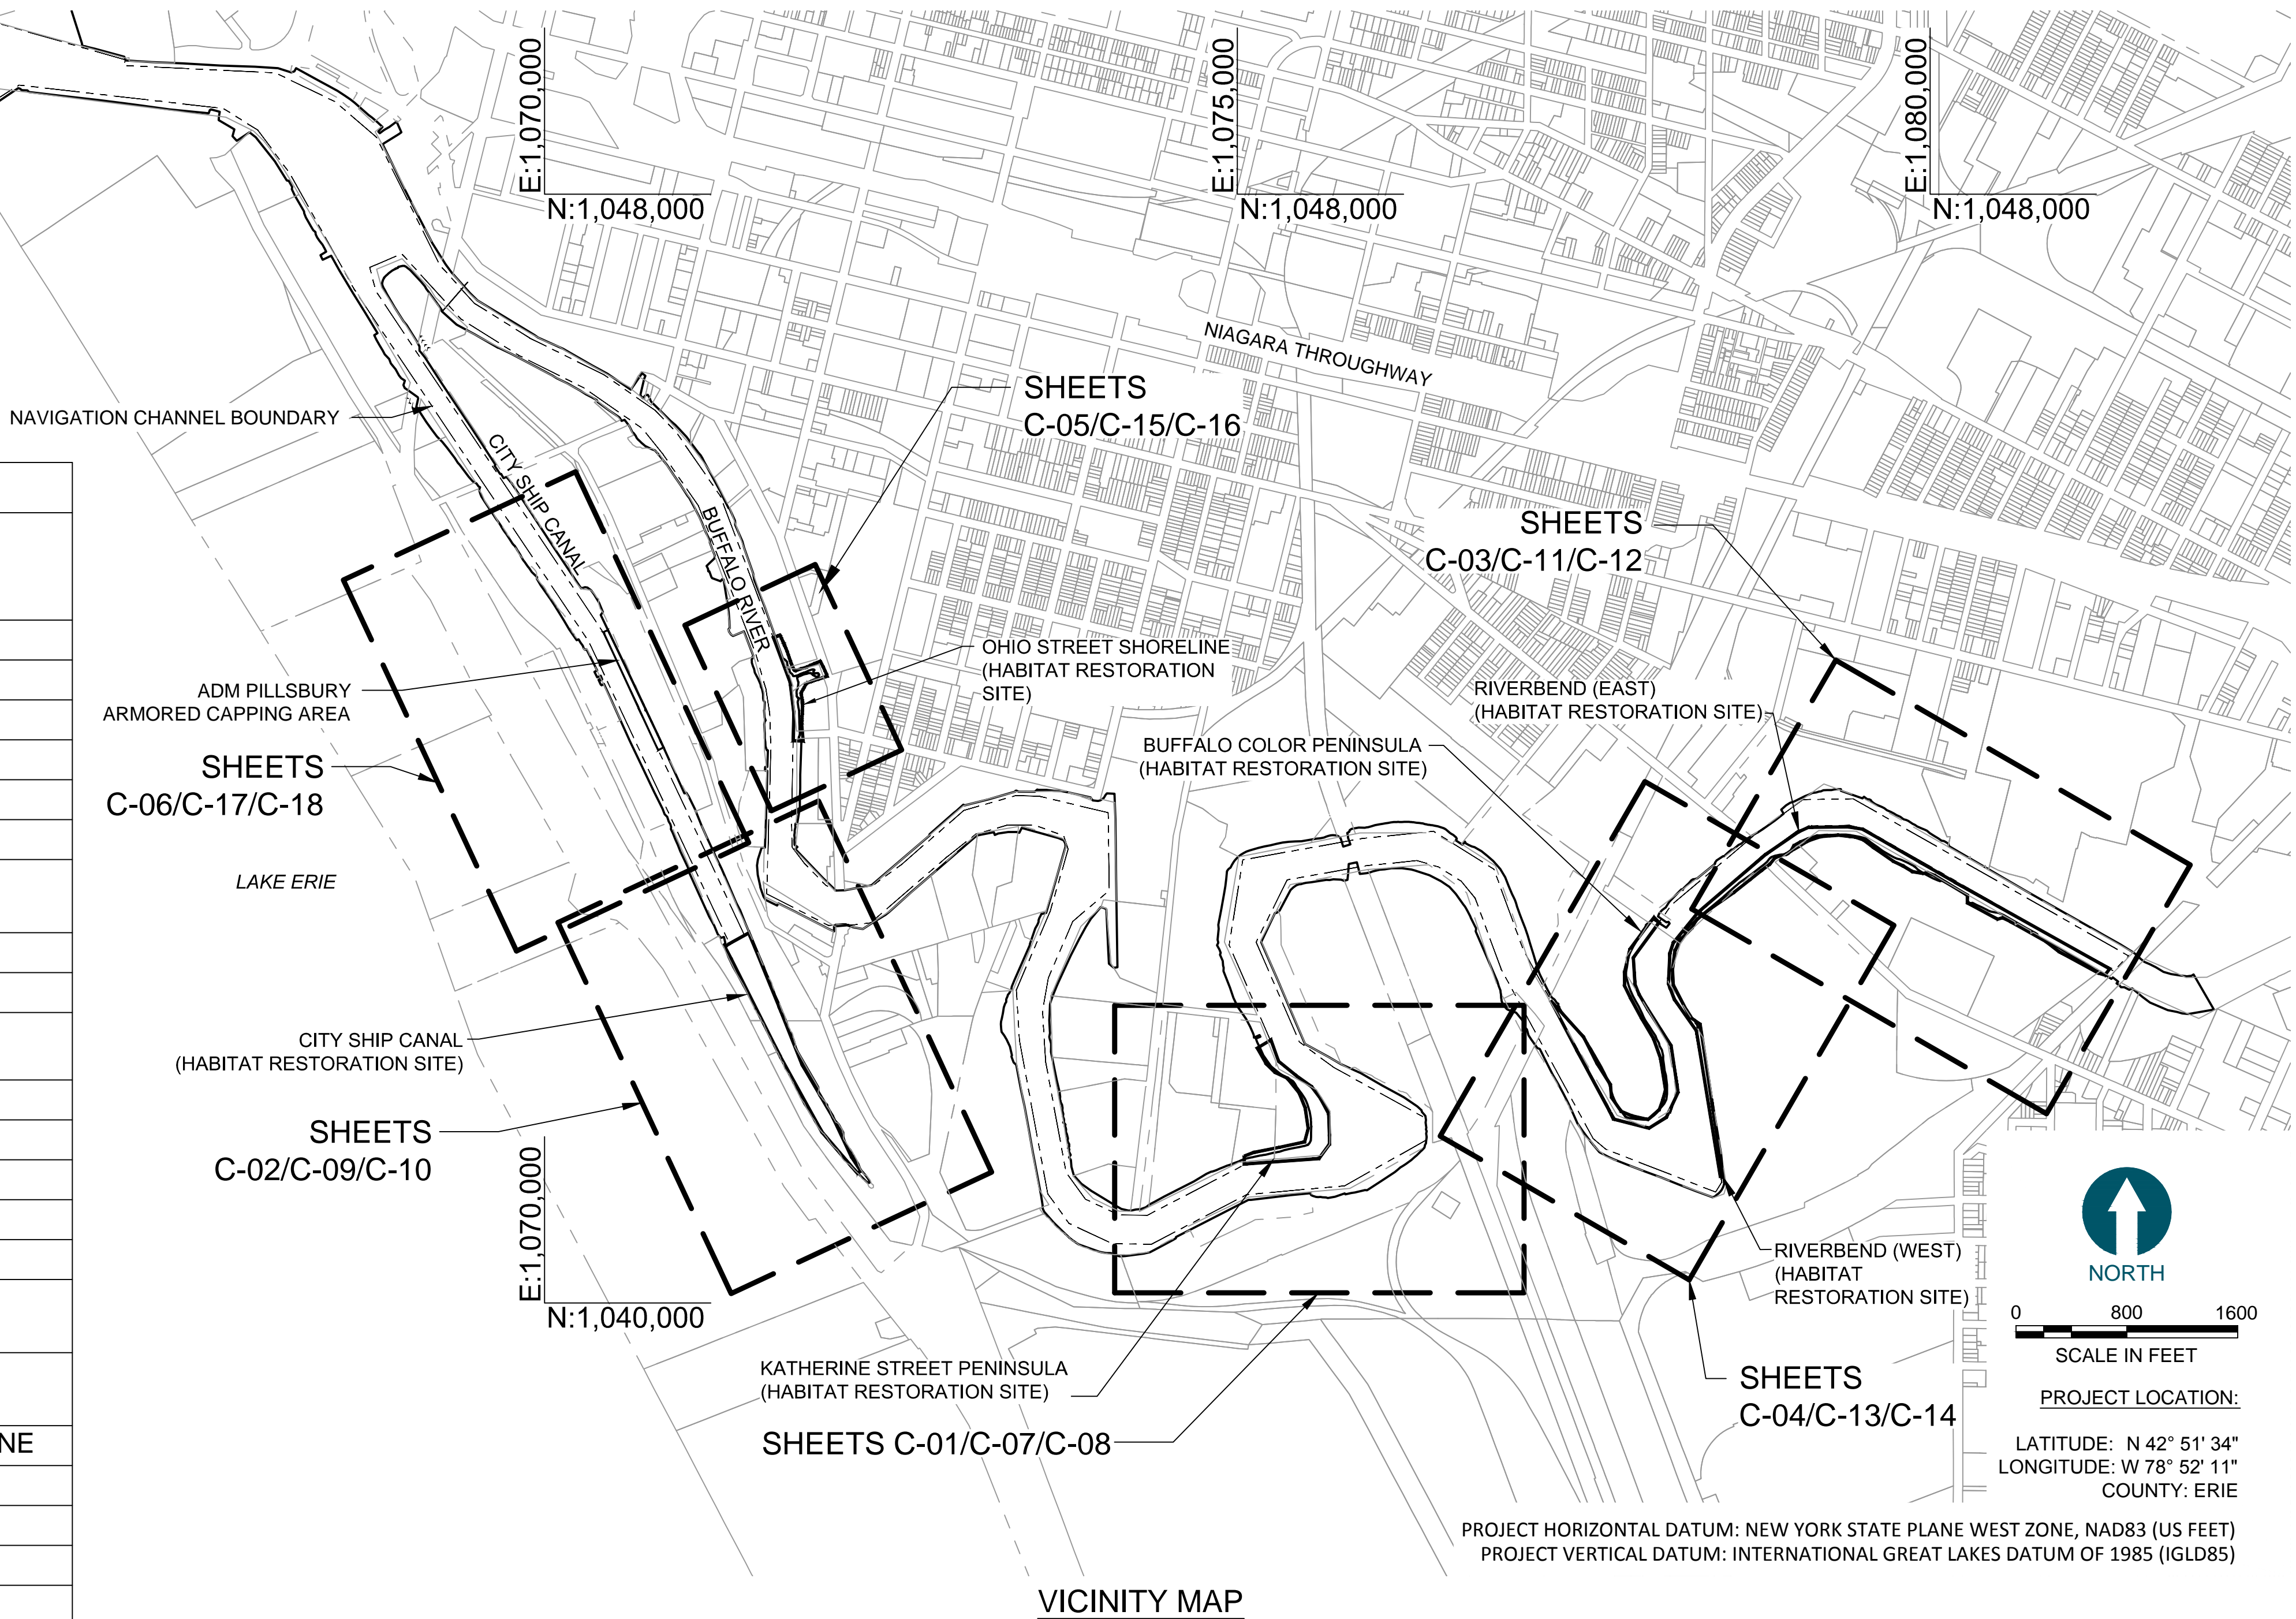

VICINITY MAP



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REVISIONS					DESCRIPTION
REV	DATE	BY	APP'D		

DESIGNED BY: M. REEMTS  
DRAWN BY: C. HEWETT  
CHECKED BY: S. BAGNULL  
APPROVED BY: P. DOODY  
DATE: MAY 2014

**BUFFALO RIVER AOC CAPPING AND HABITAT RESTORATION**

**COVER SHEET**

**T-01**

SHEET NO. **01** OF **23**



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May 19, 2014 1:05pm chevett

EXISTING LEGEND

	CONTOUR MAJOR (5 FT)
	CONTOUR MINOR (1 FT)
	NAVIGATION CHANNEL
	AVERAGE WSEL (571')
	OUTFALL
	ROAD
	ARCHEOLOGICAL POINT BF-5

PROPOSED LEGEND

	RESTORATION AREA BOUNDARY
	STAGING LOCATION
	SUBMERGED AQUATIC VEGETATION (SAV) PLANTING AREA
	EMERGENT VEGETATION (EV) PLANTING AREA
	IN-WATER FILL
	CAP AREA
	GRAVEL SPAWNING BED
	ARMORED CAP AREA
	PORCUPINE CRIB
	LOG POLE
	ROOTWAD LOG
	CONTOUR MAJOR (5 FT)
	CONTOUR MINOR (1 FT)

	DETAIL REFERENCE NAME
	DRAWING ON WHICH DETAIL APPEARS "-" INDICATES TYPICAL OR ON SAME DRAWING

	DETAIL REFERENCE NAME
	DRAWING FROM WHICH DETAIL WAS TAKEN "-" INDICATES TYPICAL OR TAKEN ON SAME DRAWING

	INDICATES DIRECTION SECTION WAS CUT
	DRAWING ON WHICH SECTION APPEARS

	SECTION REFERENCE NAME
	DRAWING FROM WHICH SECTION WAS TAKEN "-" INDICATES TYPICAL OR TAKEN ON SAME DRAWING

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SURVEY NOTES:

- TOPOGRAPHIC DATA, BATHYMETRIC DATA, UTILITY LOCATION INFORMATION, AND BASE MAP DATA FROM CH2MHILL AND ECOLOGY AND ENVIRONMENT ENGINEERING FINAL DESIGN DRAWING SET TITLED "SEDIMENT REMEDIATION DESIGN BUFFALO RIVER AREA OF CONCERN". THE BATHYMETRIC CONTOURS SHOWN ON THE EXISTING CONDITIONS SHEETS ARE BASED ON POINT DATA PROVIDED BY AFFILIATED RESEARCHERS (OCTOBER 24, 2011). IN AREAS WHERE DATA WAS NOT INCLUDED BY AFFILIATED RESEARCHERS, THE TOPOGRAPHIC AND BATHYMETRIC INFORMATION SHOWN ON THE ASSOCIATES SURVEY DRAWING WAS USED. EXISTING CONDITIONS DRAWINGS ARE NOT POST DREDGE DRAWINGS AND ACTUAL SITE TOPOGRAPHY AND BATHYMETRY MAY VARY. THE LOCATIONS OF PIERS, OUTFALLS, RAMPS AND OTHER IN-WATER STRUCTURES ARE AS NOTED IN CH2MHILL AND ECOLOGY AND ENVIRONMENT ENGINEERING FINAL DESIGN DRAWING SET. CONTRACTOR SHALL FIELD VERIFY THESE LOCATIONS FOR ACCURACY, AS APPLICABLE.
- CONTRACTOR SHALL CONFIRM ACTUAL BATHYMETRY PRIOR TO CONSTRUCTION.
- HORIZONTAL DATUM IS NEW YORK STATE PLAN WEST, NAD83, US FEET.
- VERTICAL DATUM IS INTERNATIONAL GREAT LAKES DATUM OF 1985 (IGLD85).

PROJECT INFORMATION:

PROJECT LOCATION:	BUFFALO RIVER BUFFALO, ERIE COUNTY, NEW YORK
OWNER:	HONEYWELL INTERNATIONAL
ENGINEER OF RECORD:	ANCHOR QEA ENGINEERING, PLLC 290 ELWOOD DAVIS ROAD LIVERPOOL, NY 13088 CONTACT: JOHN PAUL DOODY, P.E.

ABBREVIATIONS

ABB.	TERM
ABB.	ABBREVIATION
AC.	ACRES
ADM	ARCHER DANIELS MIDLAND
CY	CUBIC YARD
DBH	DIAMETER AT BREAST HEIGHT
DIA.	DIAMETER
DMU	DREDGE MANAGEMENT UNIT
EA.	EACH
EL.	ELEVATION
EX	EXISTING
FT.	FOOT OR FEET
GALV.	GALVANIZED
IN.	INCH OR INCHES
LOC.	LOCATION
LWD	LOW WATER DATUM
MAX.	MAXIMUM
MIN.	MINIMUM
MM	MILLIMETERS
N/A	NOT APPLICABLE
NTS	NOT TO SCALE
O.C.	ON CENTER
P.E.	PROFESSIONAL ENGINEER
QTY.	QUANTITY
SF	SQUARE FOOT OR FEET
SPEC.	SPECIFICATION(S)
SY	SQUARE YARD
TESC	TEMPORARY EROSION AND SEDIMENTATION CONTROL
TYP.	TYPICAL
WSEL	WATER SURFACE ELEVATION

PLANT SCHEDULE: EMERGENT VEGETATION (EV)

PLANT SCHEDULE: EMERGENT VEGETATION (EV)				TOTAL AREA				
COMMON NAME	SPECIES NAME	PLANTING ZONES	SPECIES PROPORTIONS	KATHERINE STREET	CITY SHIP CANAL	RIVERBEND (EAST AND WEST)	BUFFALO COLOR PENINSULA	OHIO STREET SHORELINE
AMERICAN WATER PLANTAIN	<i>Alisma subcordatum</i>	ALL ZONES (TOLERATES 1-2' WATER DEPTH)	FOR EACH RESTORATION AREA, AT LEAST EIGHT EMERGENT PLANT SPECIES MUST BE SELECTED FROM THE LIST AND NO SPECIES SHALL COMPRISE MORE THAN 40% OF THE TOTAL QUANTITY	0.18 AC.	0.83 AC.	0.88 AC.	1.17 AC.	0.05 AC.
TUSSOCK SEDGE	<i>Carex stricta</i>	ALL ZONES (TOLERATES 1-2' WATER DEPTH)						
FOX SEDGE	<i>Carex vulpinoides</i>	HIGH ZONE (TOLERATES 0.5' WATER DEPTH)						
SMALL SPIKE RUSH	<i>Eleocharis parvula</i>	HIGH ZONE (TOLERATES 0.5' WATER DEPTH)						
SOFT RUSH	<i>Juncus effusus</i>	MIDDLE ZONE (TOLERATES 1' WATER DEPTH)						
AMERICAN WATERWILLOW	<i>Justicia americana</i>	MIDDLE ZONE (TOLERATES 1' WATER DEPTH)						
WATER SMARTWEED	<i>Polygonum amphibium</i>	MIDDLE ZONE (TOLERATES 1' WATER DEPTH)						
RIVER BULRUSH	<i>Schoenoplectus fluviatilis</i>	MIDDLE ZONE (TOLERATES 1' WATER DEPTH)						
SOFT STEM BULRUSH	<i>Schoenoplectus tabernaemontani</i>	MIDDLE ZONE (TOLERATES 1' WATER DEPTH)						
WOOL GRASS	<i>Scirpus cyperinus</i>	HIGH ZONE (TOLERATES 0.5' WATER DEPTH)						

PLANT SCHEDULE: SUBMERGED AQUATIC VEGETATION (SAV)

PLANT SCHEDULE: SUBMERGED AQUATIC VEGETATION (SAV)				TOTAL AREA				
COMMON NAME	SPECIES NAME	PLANTING ZONES	SPECIES PROPORTIONS	KATHERINE STREET	CITY SHIP CANAL	RIVERBEND (EAST AND WEST)	BUFFALO COLOR PENINSULA	OHIO STREET SHORELINE
COMMON WATERWEED	<i>Elodea canadensis</i>	ALL (TOLERATES WATER DEPTHS TO 6')	FOR EACH RESTORATION AREA, AT LEAST THREE SUBMERGED AQUATIC PLANT SPECIES MUST BE SELECTED FROM THE LIST; ONE OF THE SPECIES MUST BE WILD CELERY, WHICH CAN COMPRISE UP TO 75% OF THE TOTAL QUANTITY.	1.02 AC.	2.46 AC.	0.48 AC.	0.42 AC.	N/A
FLOATING PONDWEED	<i>Potamogeton natans</i>	ALL (TOLERATES WATER DEPTHS TO 6')						
AMERICAN PONDWEED	<i>Potamogeton nodosus</i>	ALL (TOLERATES WATER DEPTHS TO 6')						
SAGO PONDWEED	<i>Stuckenia pectinata</i>	ALL (TOLERATES WATER DEPTHS TO 6')						
WILD CELERY	<i>Vallisneria americana</i>	ALL (TOLERATES WATER DEPTHS TO 6')						



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REVISIONS					
REV	DATE	BY	APP'D	DESCRIPTION	

DESIGNED BY: M. REEMTS  
DRAWN BY: C. HEWETT  
CHECKED BY: S. BAGNULL  
APPROVED BY: P. DOODY  
DATE: MAY 2014

BUFFALO RIVER AOC CAPPING AND HABITAT  
RESTORATION






GENERAL NOTES, LEGEND, AND  
PLANTING SCHEDULE

G-01

SHEET NO. 02 OF 23

ONE INCH  
↑  
AT FULL SIZE, IF NOT ONE  
INCH SCALE ACCORDINGLY  
↓



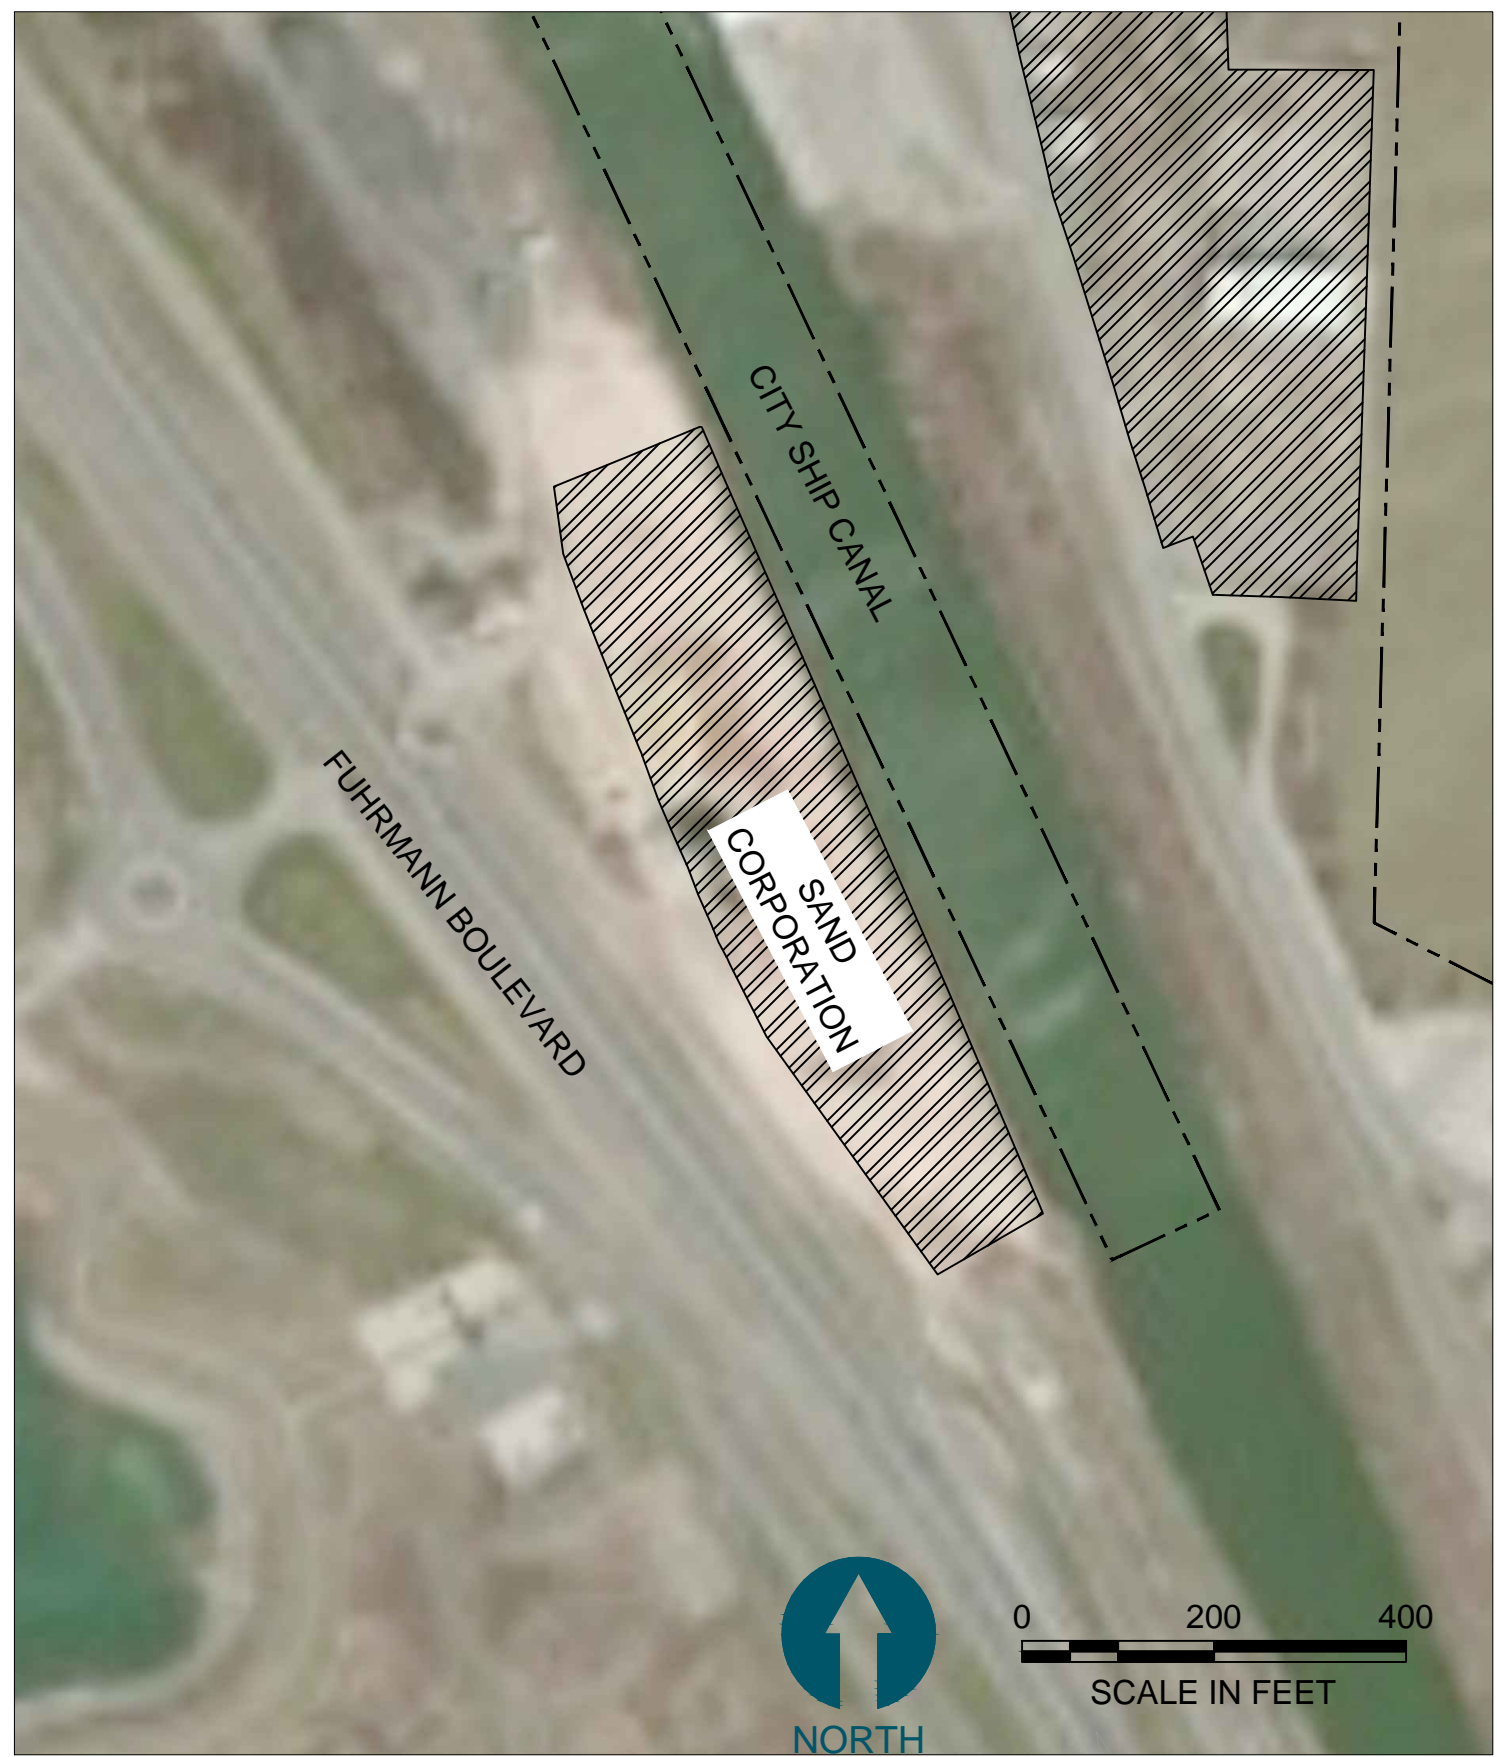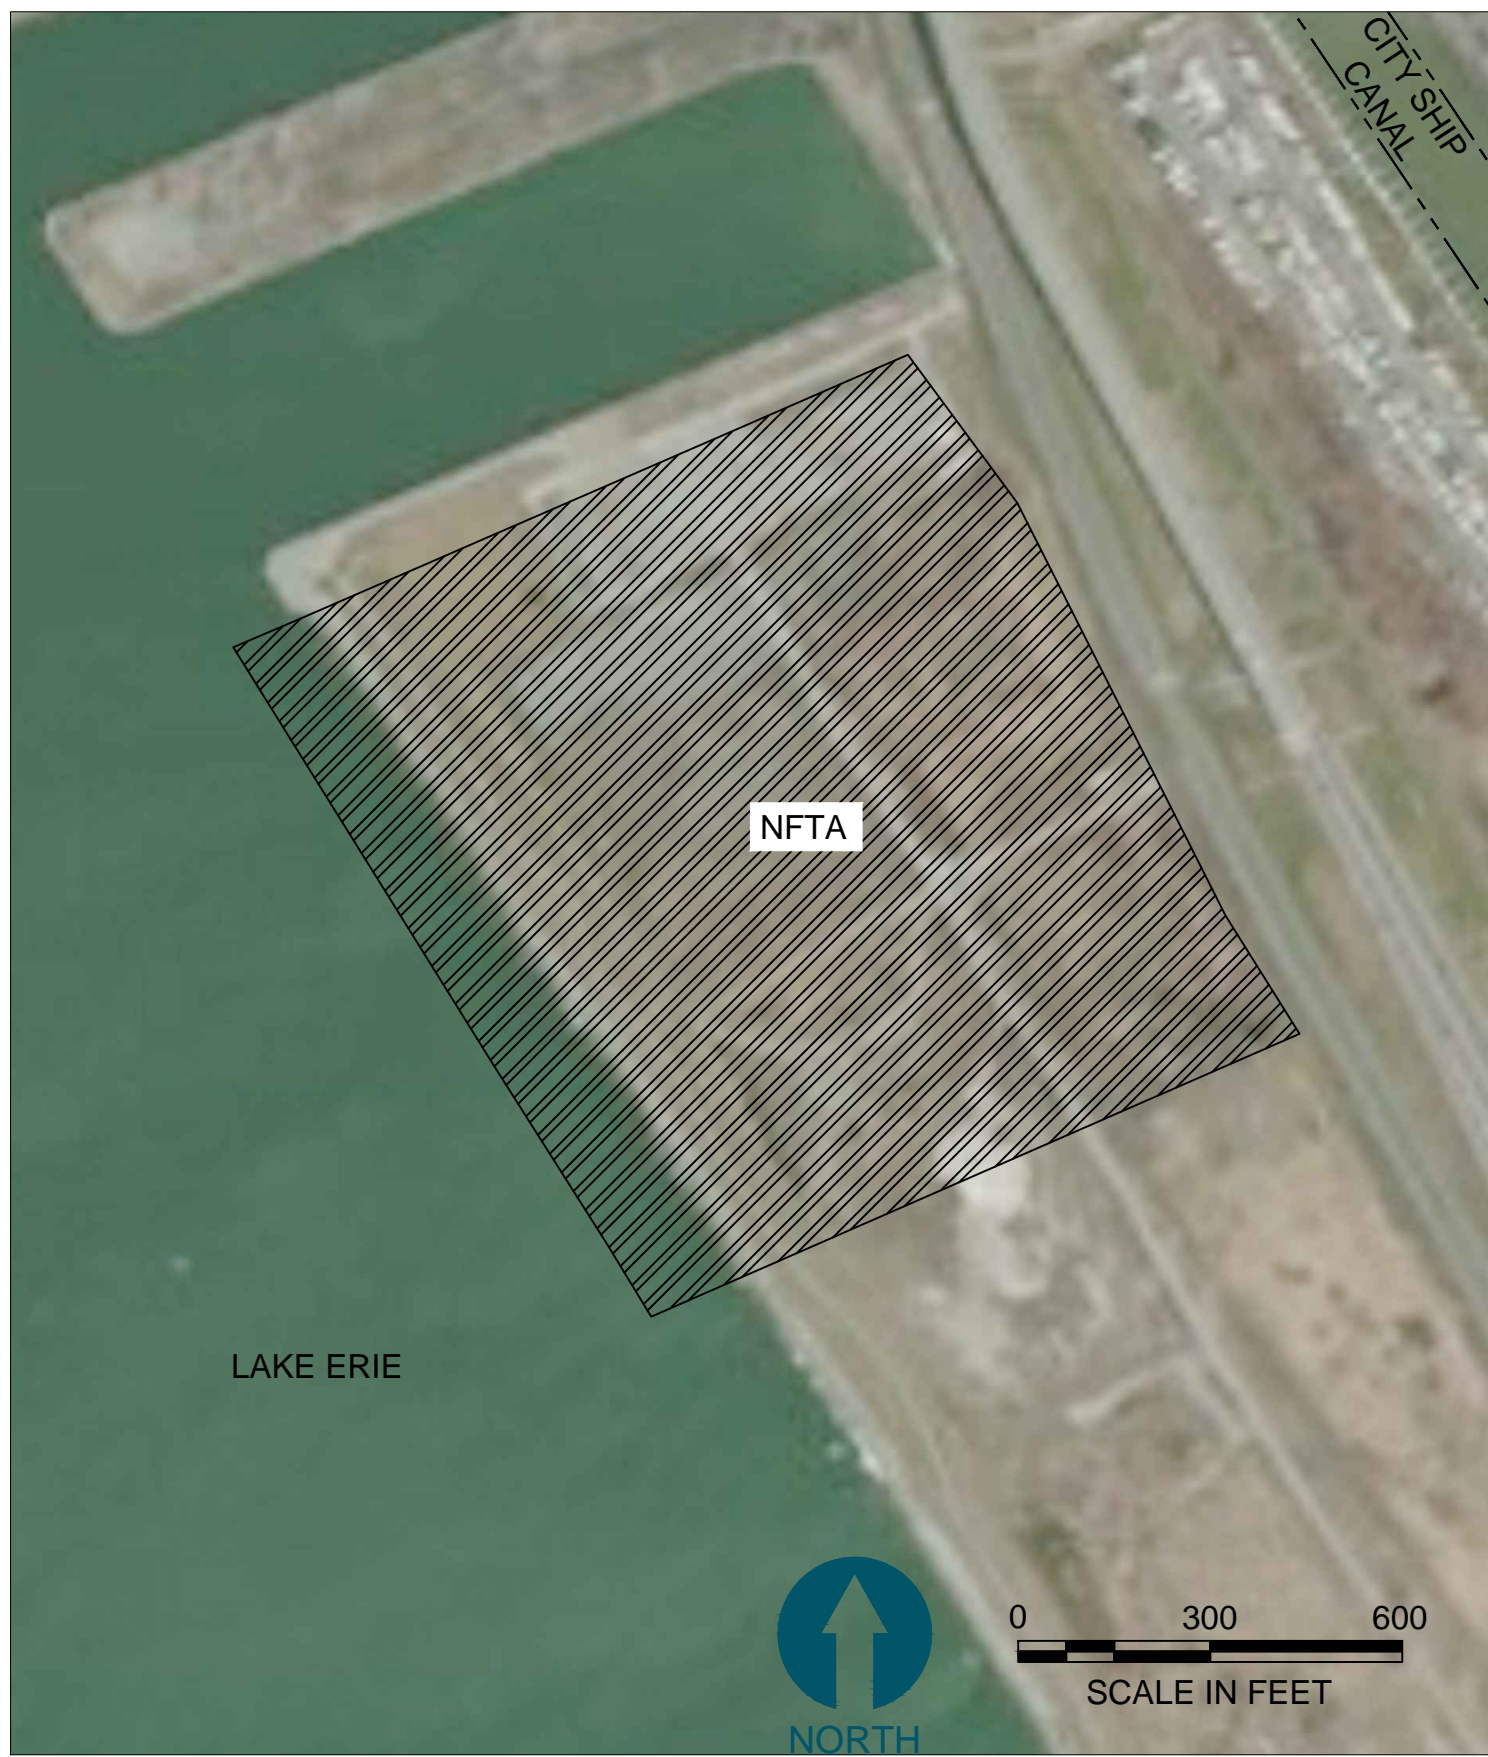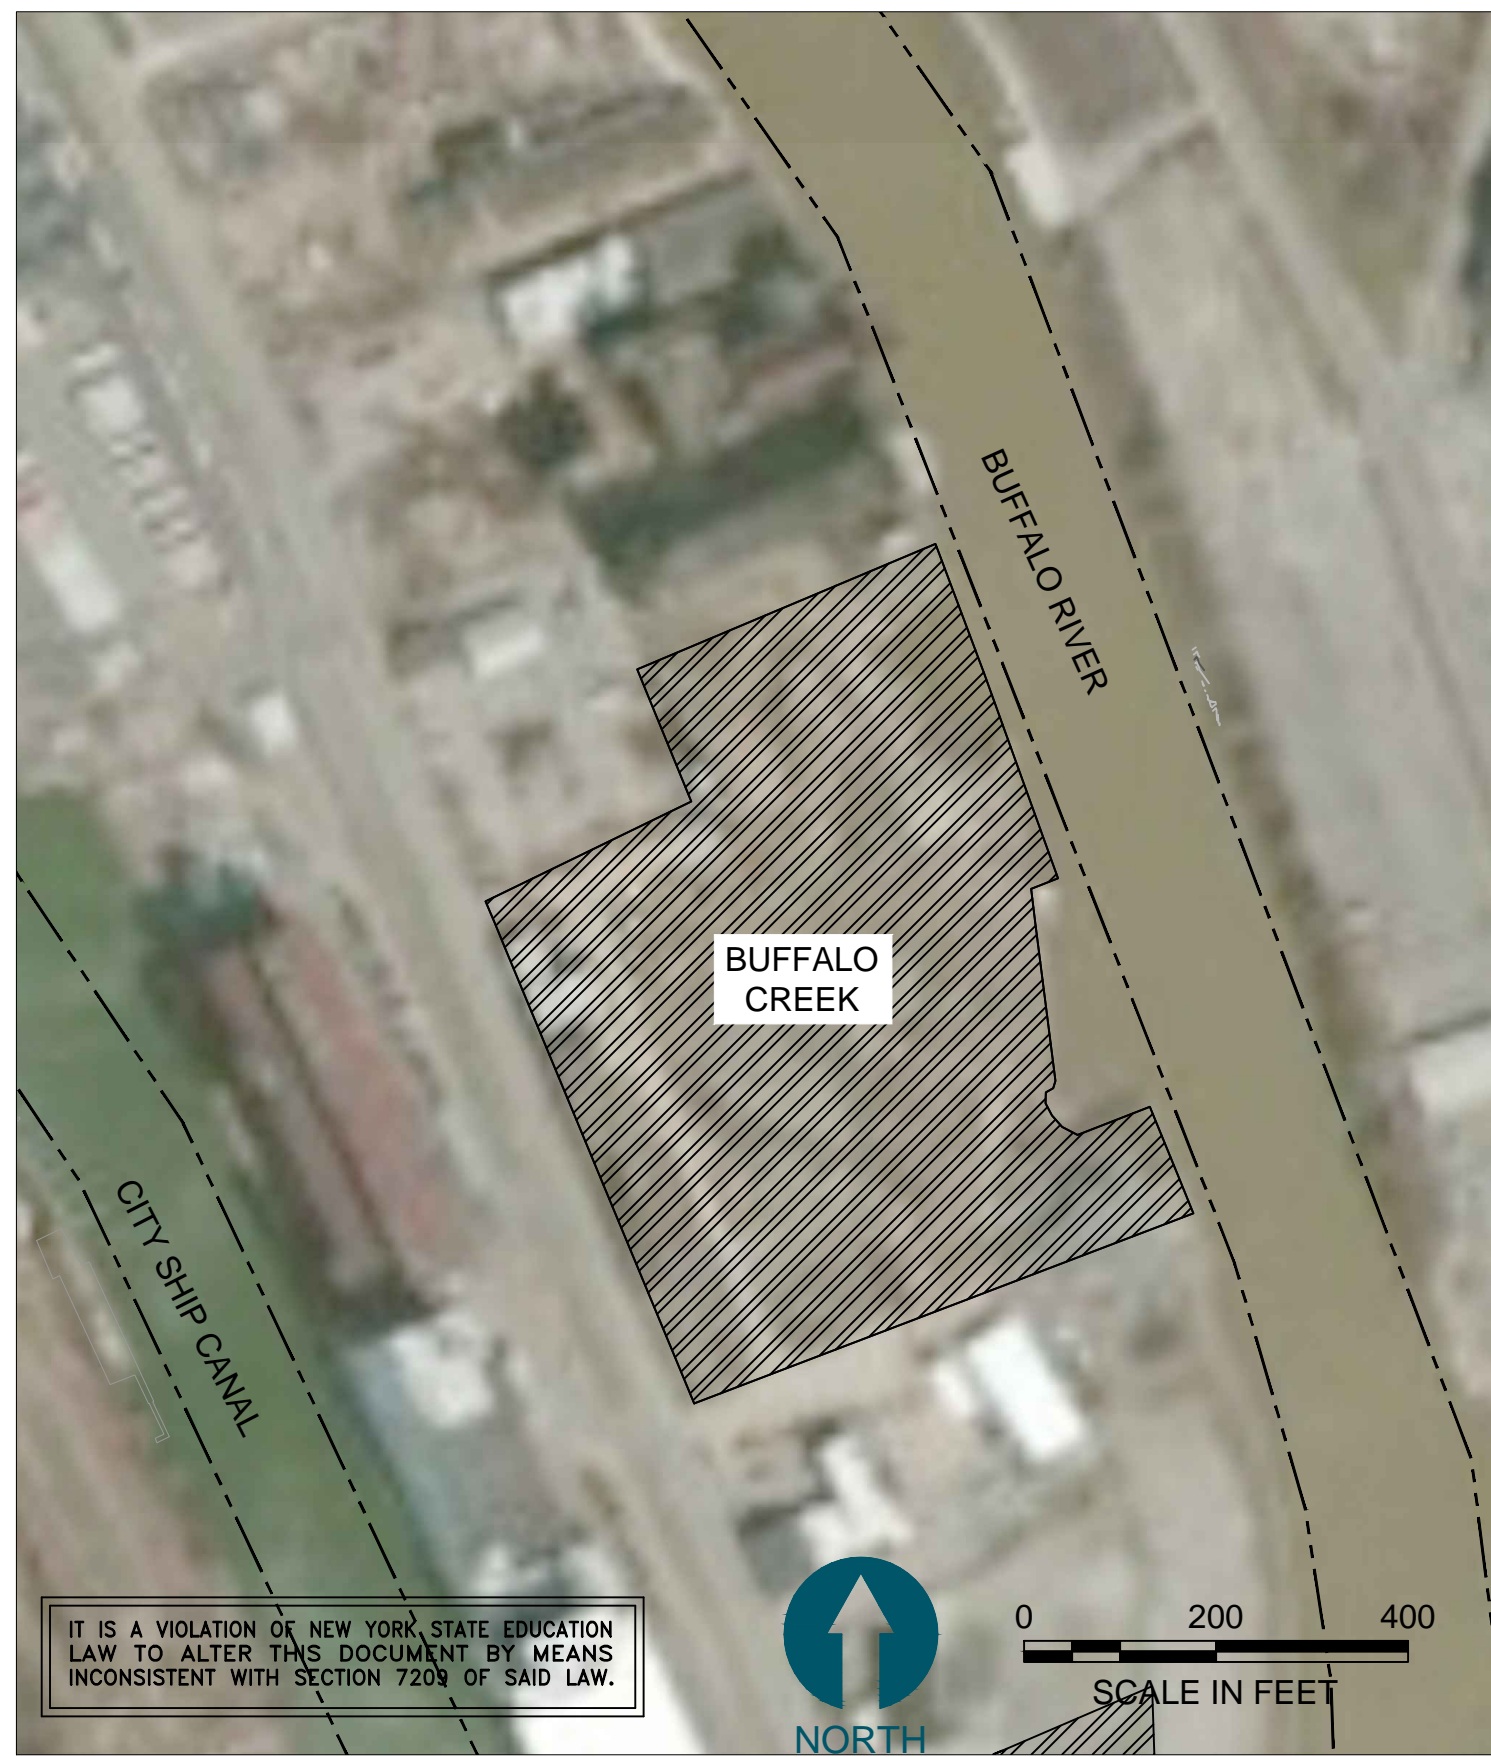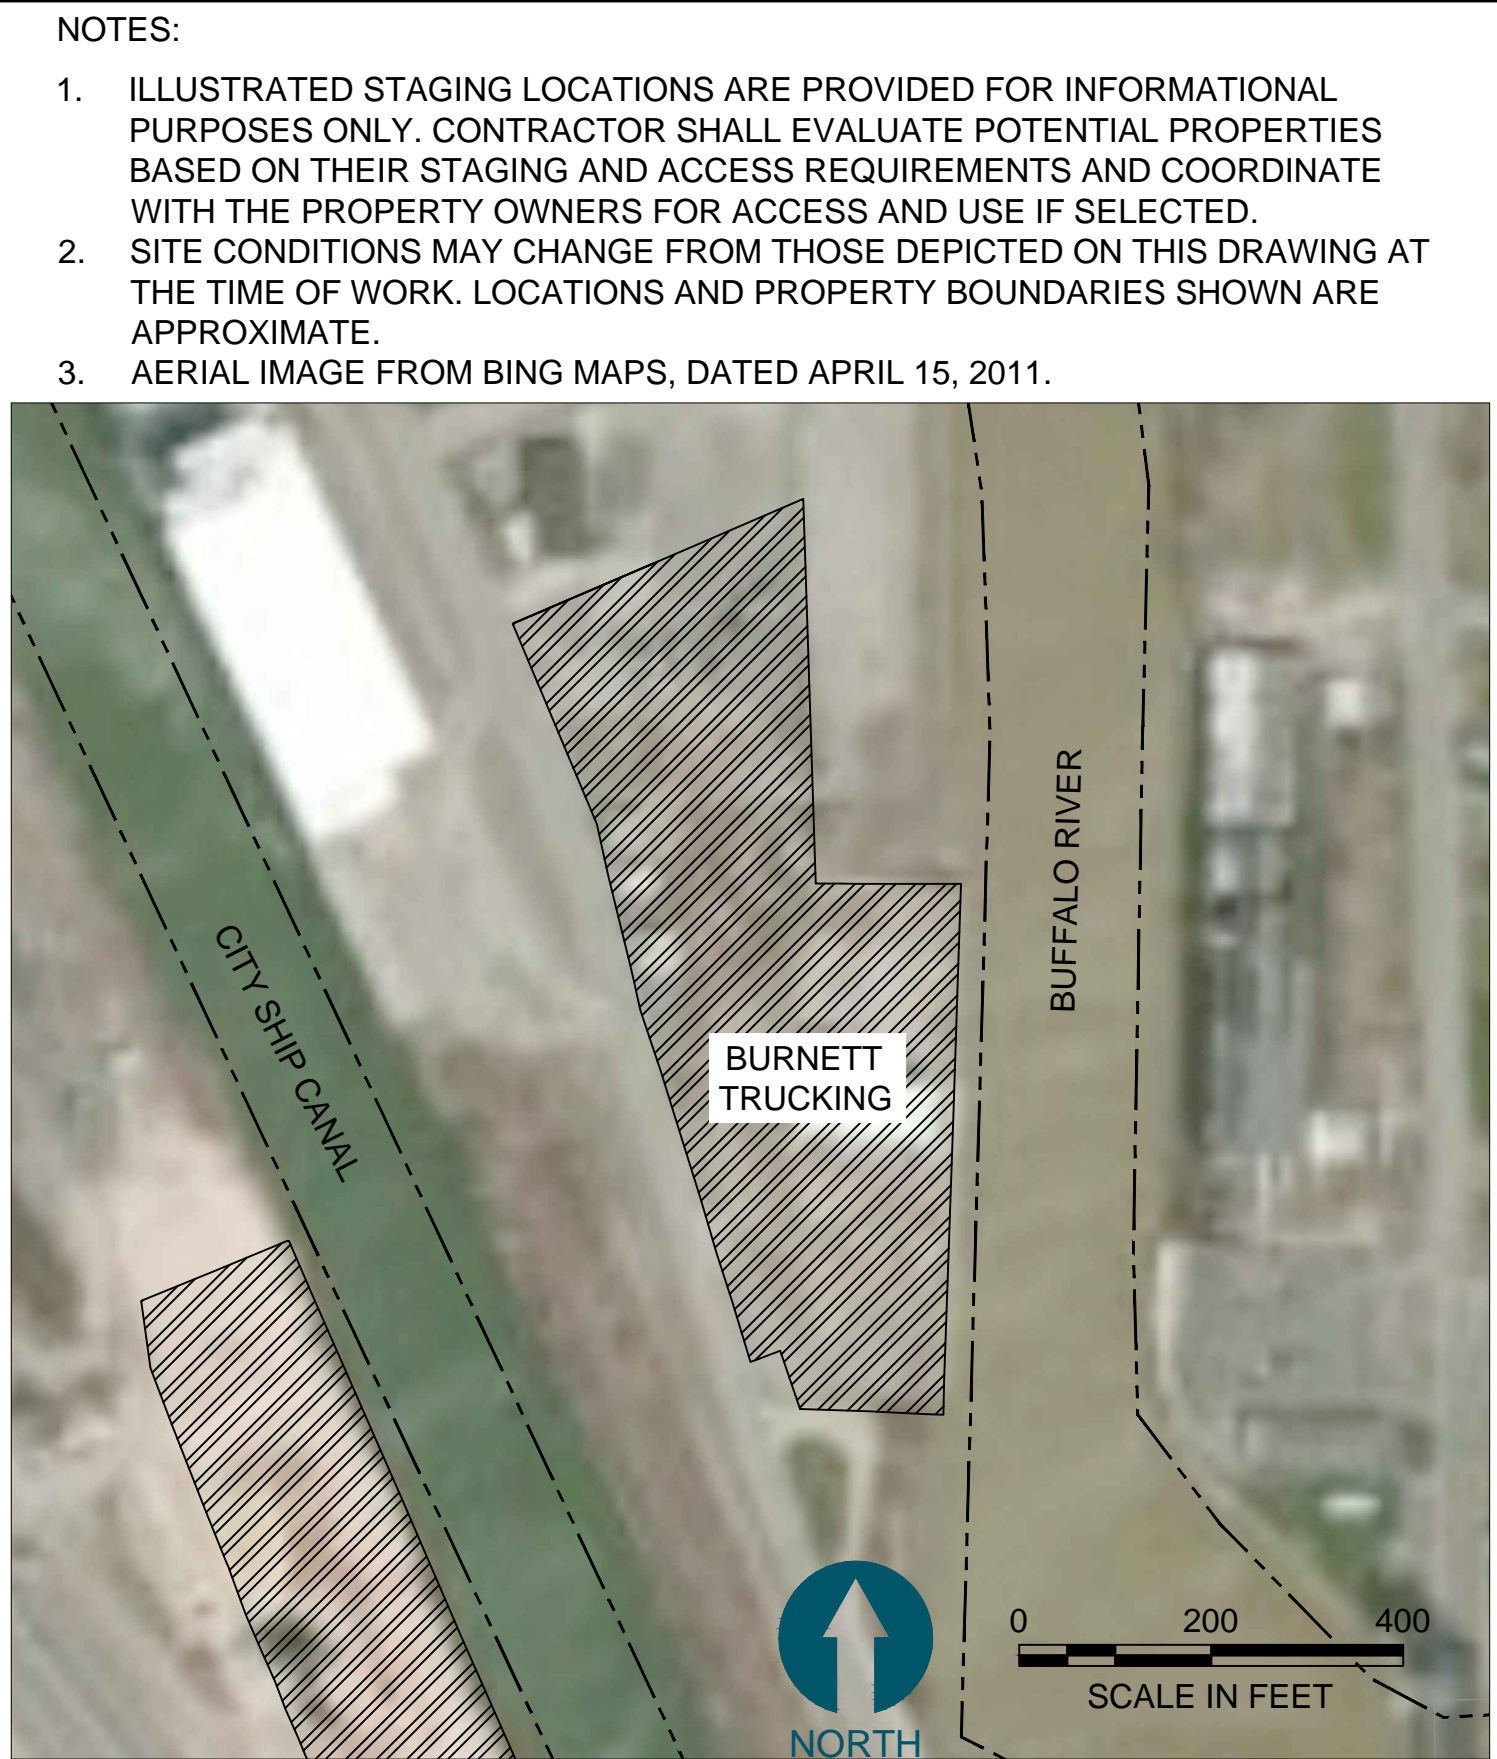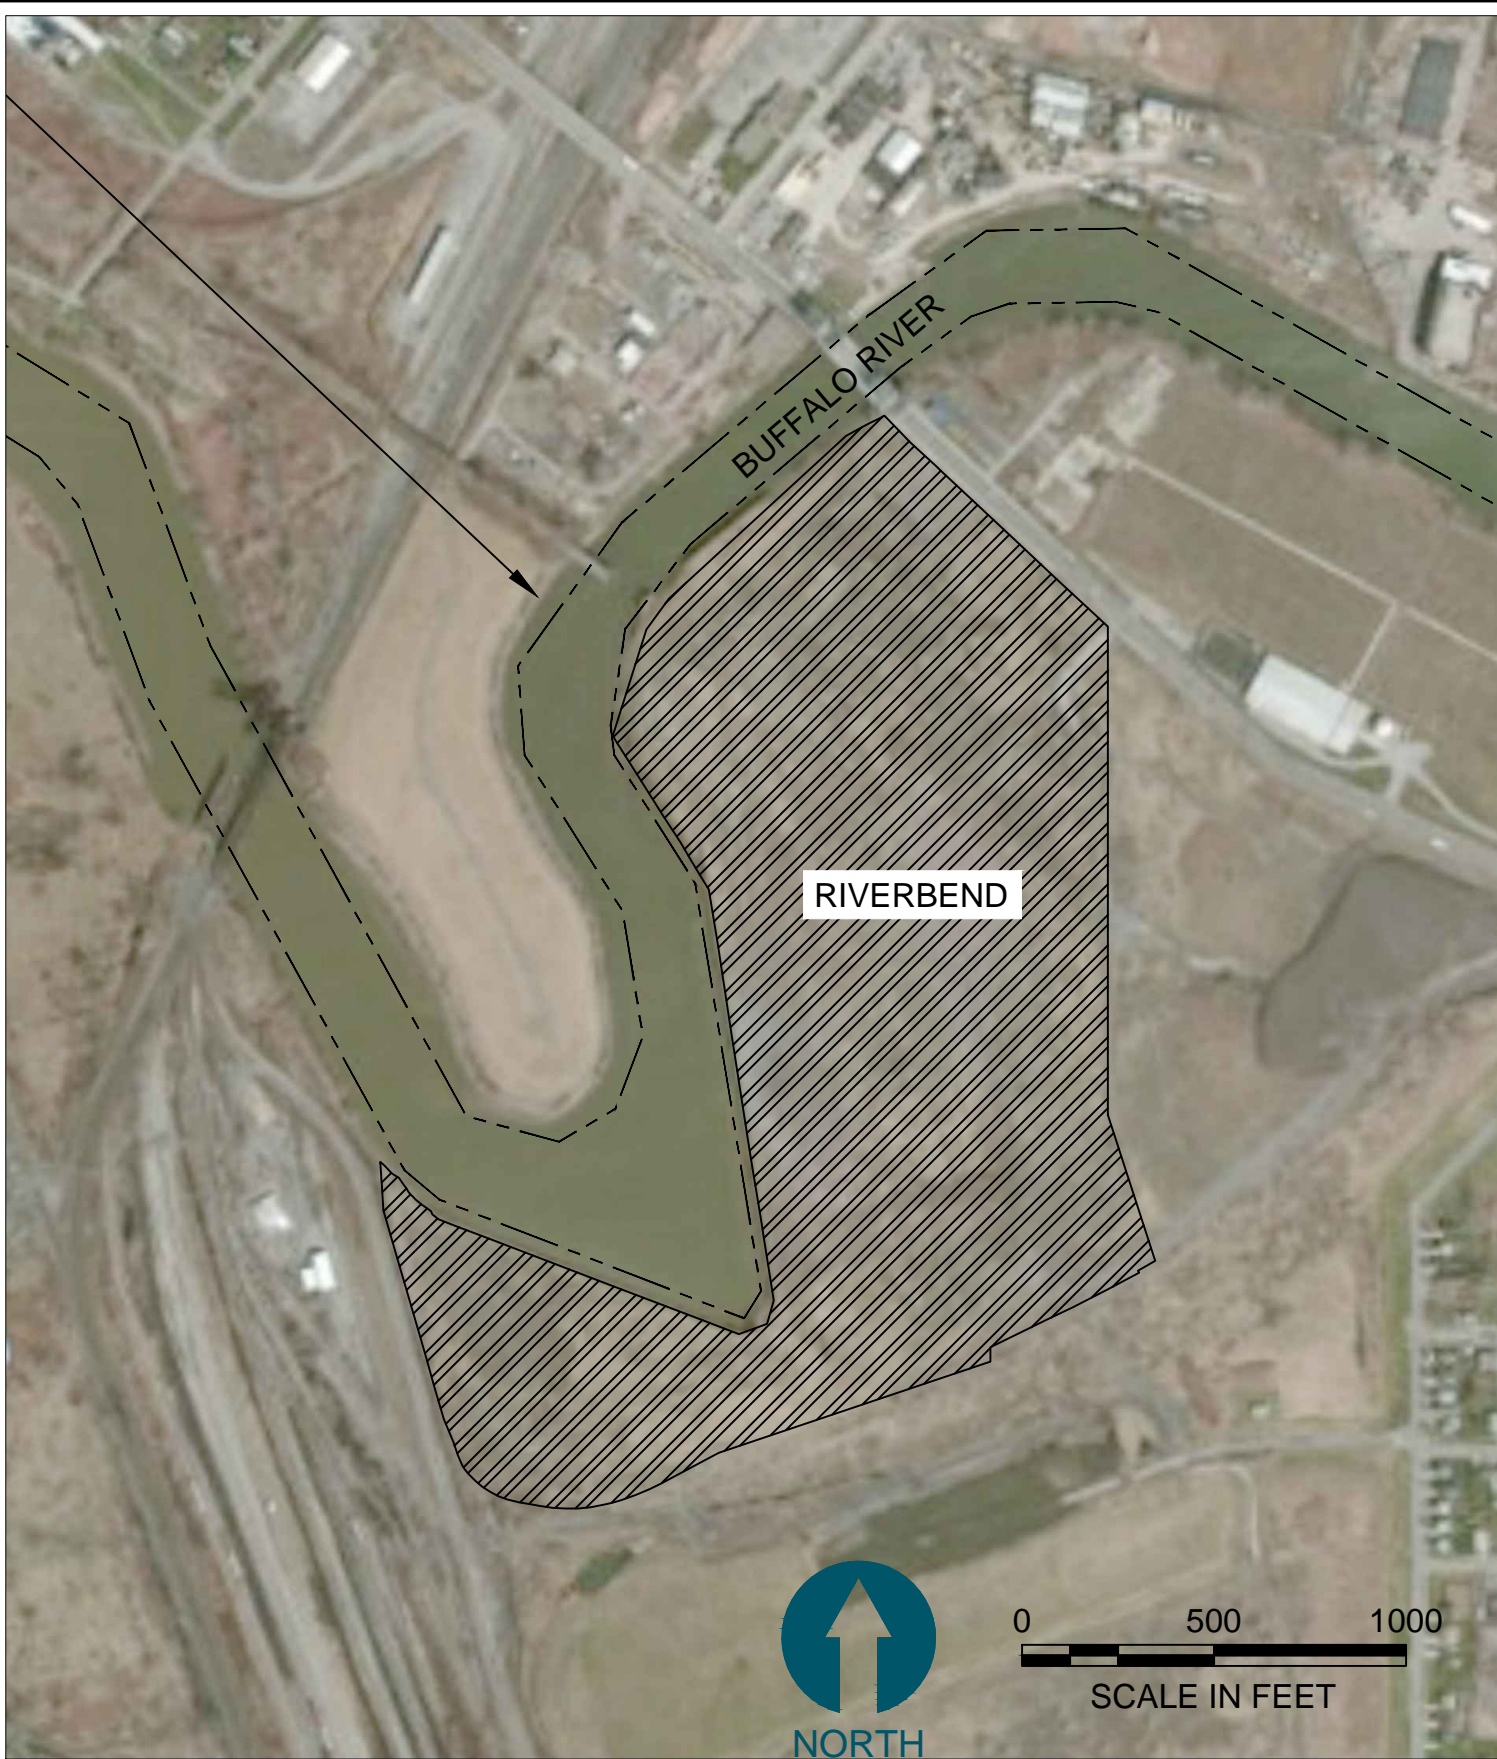

- NOTES:
1. ILLUSTRATED STAGING LOCATIONS ARE PROVIDED FOR INFORMATIONAL PURPOSES ONLY. CONTRACTOR SHALL EVALUATE POTENTIAL PROPERTIES BASED ON THEIR STAGING AND ACCESS REQUIREMENTS AND COORDINATE WITH THE PROPERTY OWNERS FOR ACCESS AND USE IF SELECTED.
  2. SITE CONDITIONS MAY CHANGE FROM THOSE DEPICTED ON THIS DRAWING AT THE TIME OF WORK. LOCATIONS AND PROPERTY BOUNDARIES SHOWN ARE APPROXIMATE.
  3. AERIAL IMAGE FROM BING MAPS, DATED APRIL 15, 2011.

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**BUFFALO RIVER AOC CAPPING AND HABITAT RESTORATION**


**STAGING LOCATION OPTIONS**

**G-02**


SHEET NO. **03** OF **23**



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May 19, 2014 1:08pm chewet

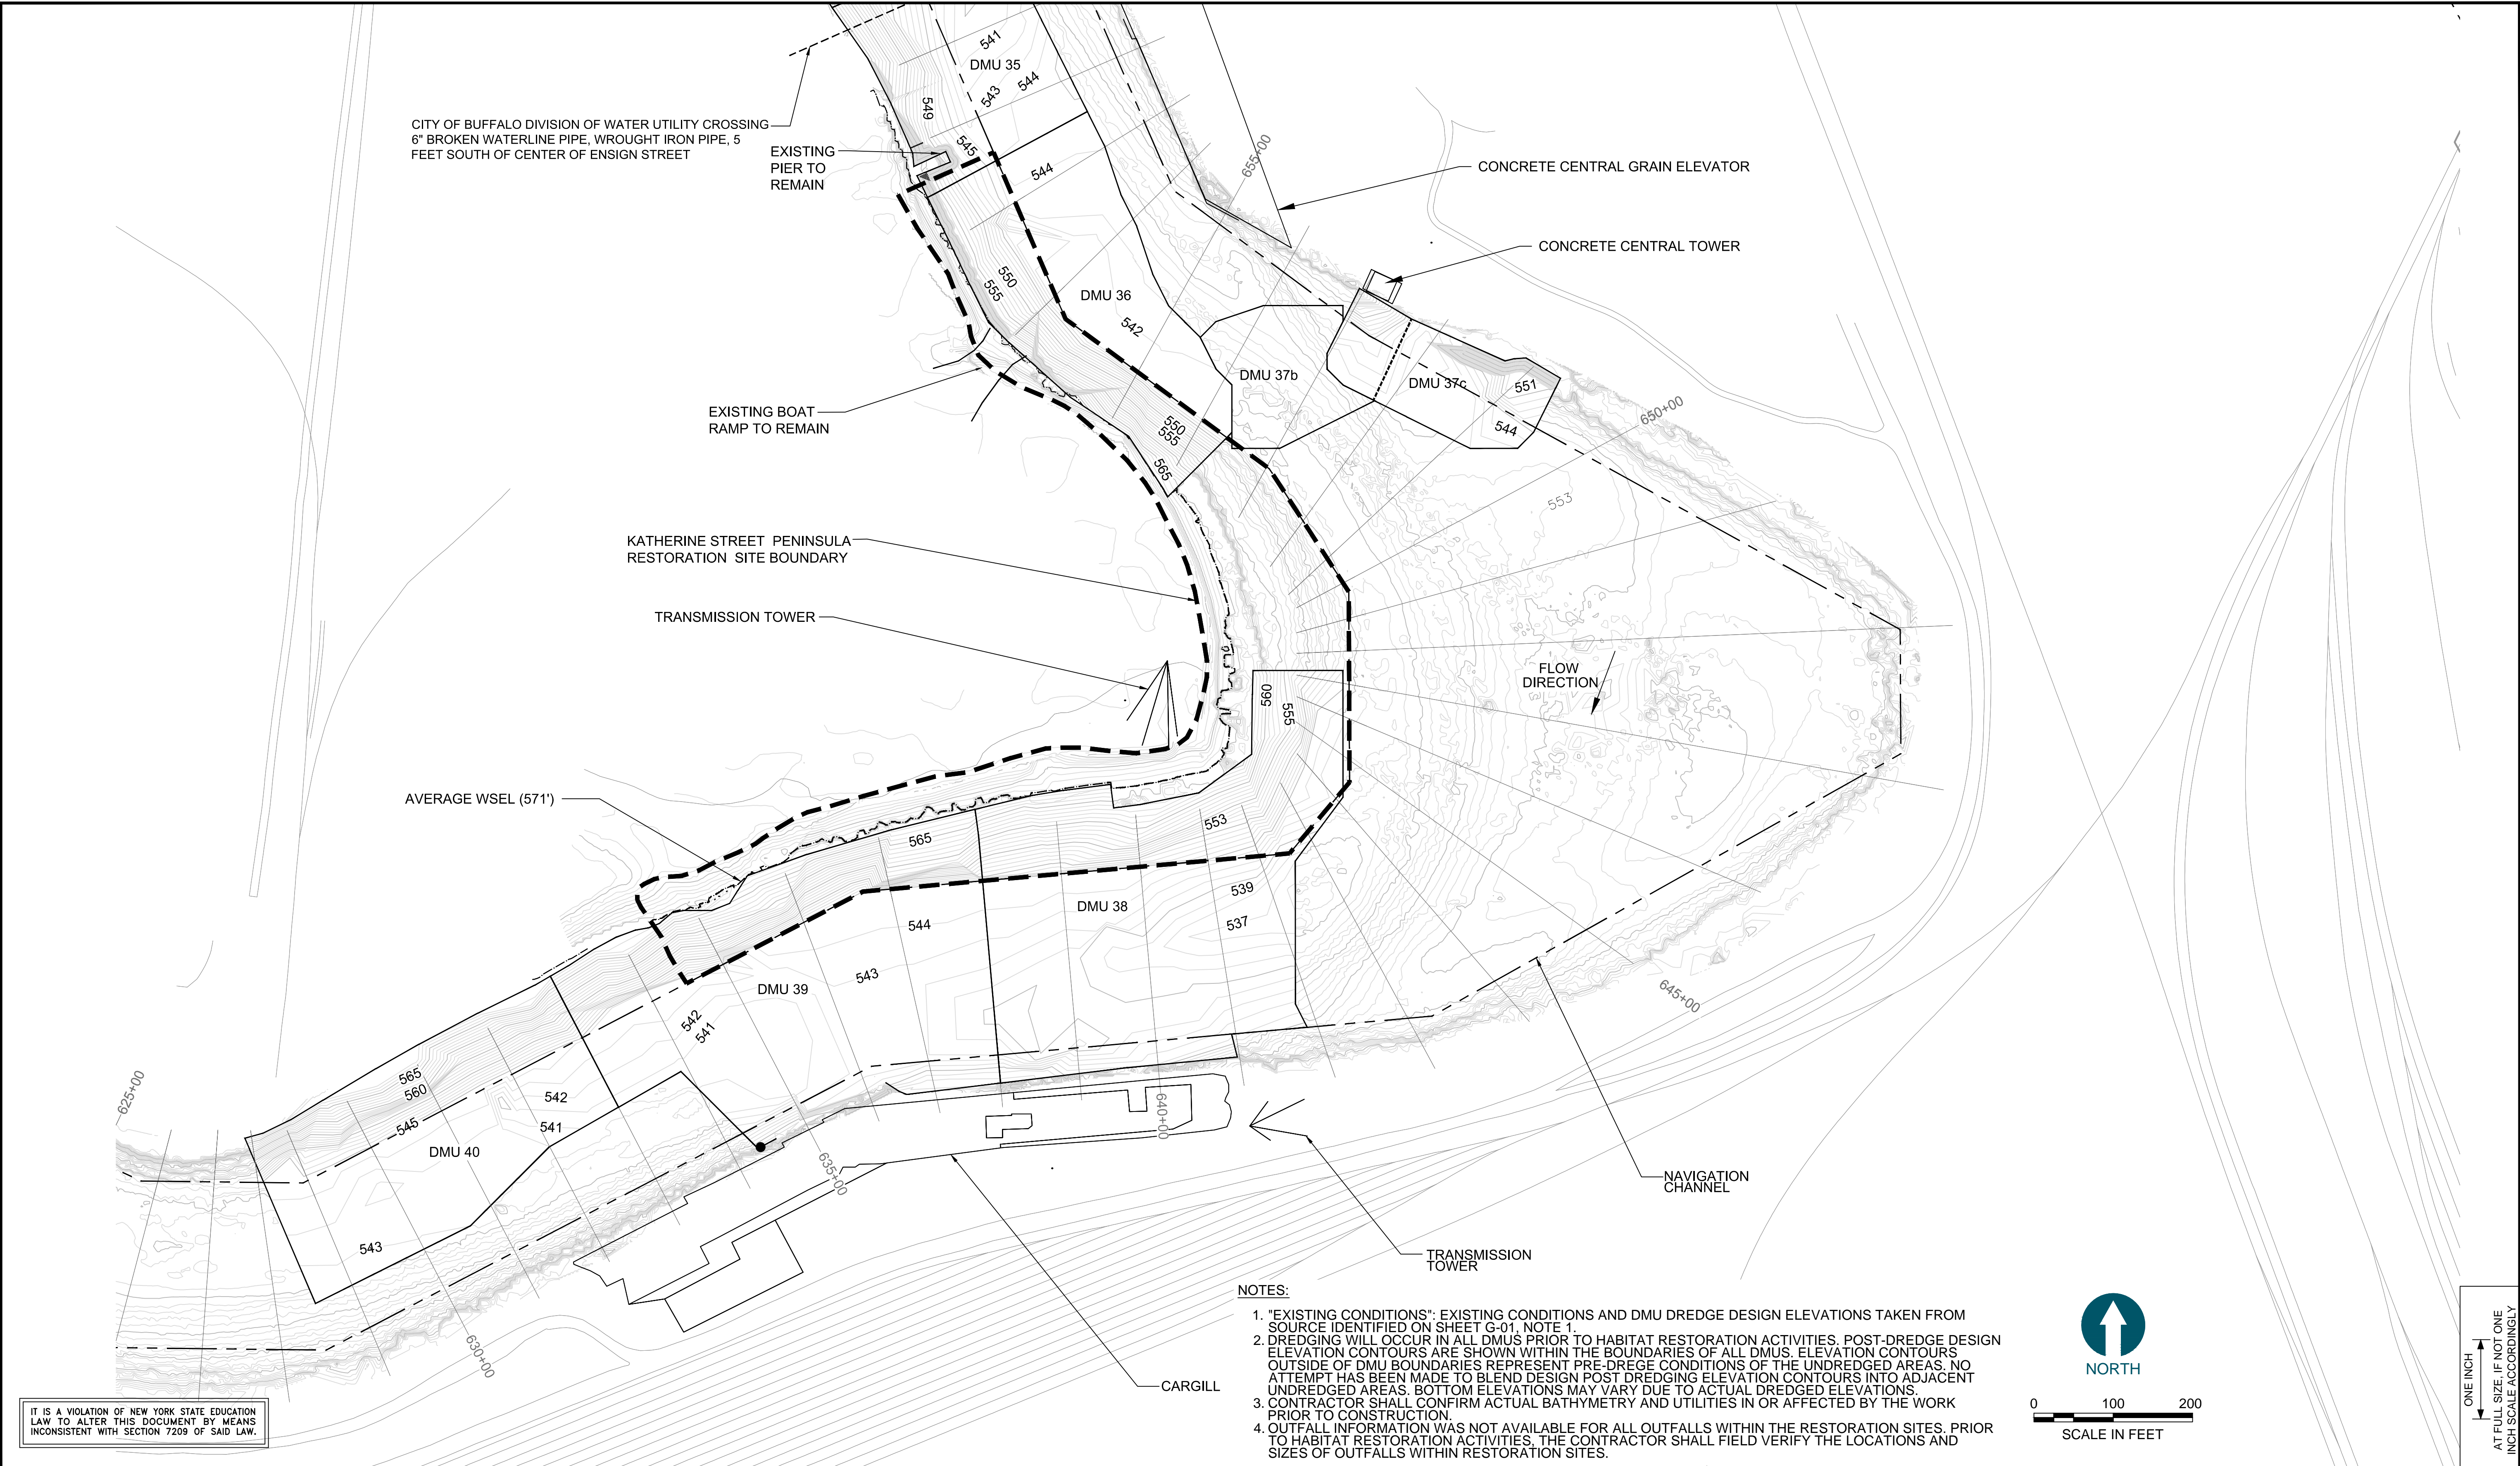

- NOTES:
1. "EXISTING CONDITIONS": EXISTING CONDITIONS AND DMU DREDGE DESIGN ELEVATIONS TAKEN FROM SOURCE IDENTIFIED ON SHEET G-01, NOTE 1.
  2. DREDGING WILL OCCUR IN ALL DMUS PRIOR TO HABITAT RESTORATION ACTIVITIES. POST-DREDGE DESIGN ELEVATION CONTOURS ARE SHOWN WITHIN THE BOUNDARIES OF ALL DMUS. ELEVATION CONTOURS OUTSIDE OF DMU BOUNDARIES REPRESENT PRE-DREGE CONDITIONS OF THE UNDREDGED AREAS. NO ATTEMPT HAS BEEN MADE TO BLEND DESIGN POST DREDGING ELEVATION CONTOURS INTO ADJACENT UNDREDGED AREAS. BOTTOM ELEVATIONS MAY VARY DUE TO ACTUAL DREDGED ELEVATIONS.
  3. CONTRACTOR SHALL CONFIRM ACTUAL BATHYMETRY AND UTILITIES IN OR AFFECTED BY THE WORK PRIOR TO CONSTRUCTION.
  4. OUTFALL INFORMATION WAS NOT AVAILABLE FOR ALL OUTFALLS WITHIN THE RESTORATION SITES. PRIOR TO HABITAT RESTORATION ACTIVITIES, THE CONTRACTOR SHALL FIELD VERIFY THE LOCATIONS AND SIZES OF OUTFALLS WITHIN RESTORATION SITES.

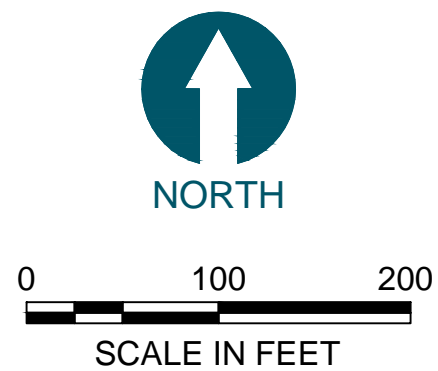

ONE INCH  
↑  
AT FULL SIZE, IF NOT ONE  
INCH SCALE ACCORDINGLY

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DRAWN BY: C. HEWETT  
CHECKED BY: S. BAGNULL  
APPROVED BY: P. DOODY  
DATE: MAY 2014

**BUFFALO RIVER AOC CAPPING AND HABITAT  
RESTORATION**

**EXISTING CONDITIONS - KATHERINE  
STREET PENINSULA**

**C-01**

SHEET NO. **04** OF **23**



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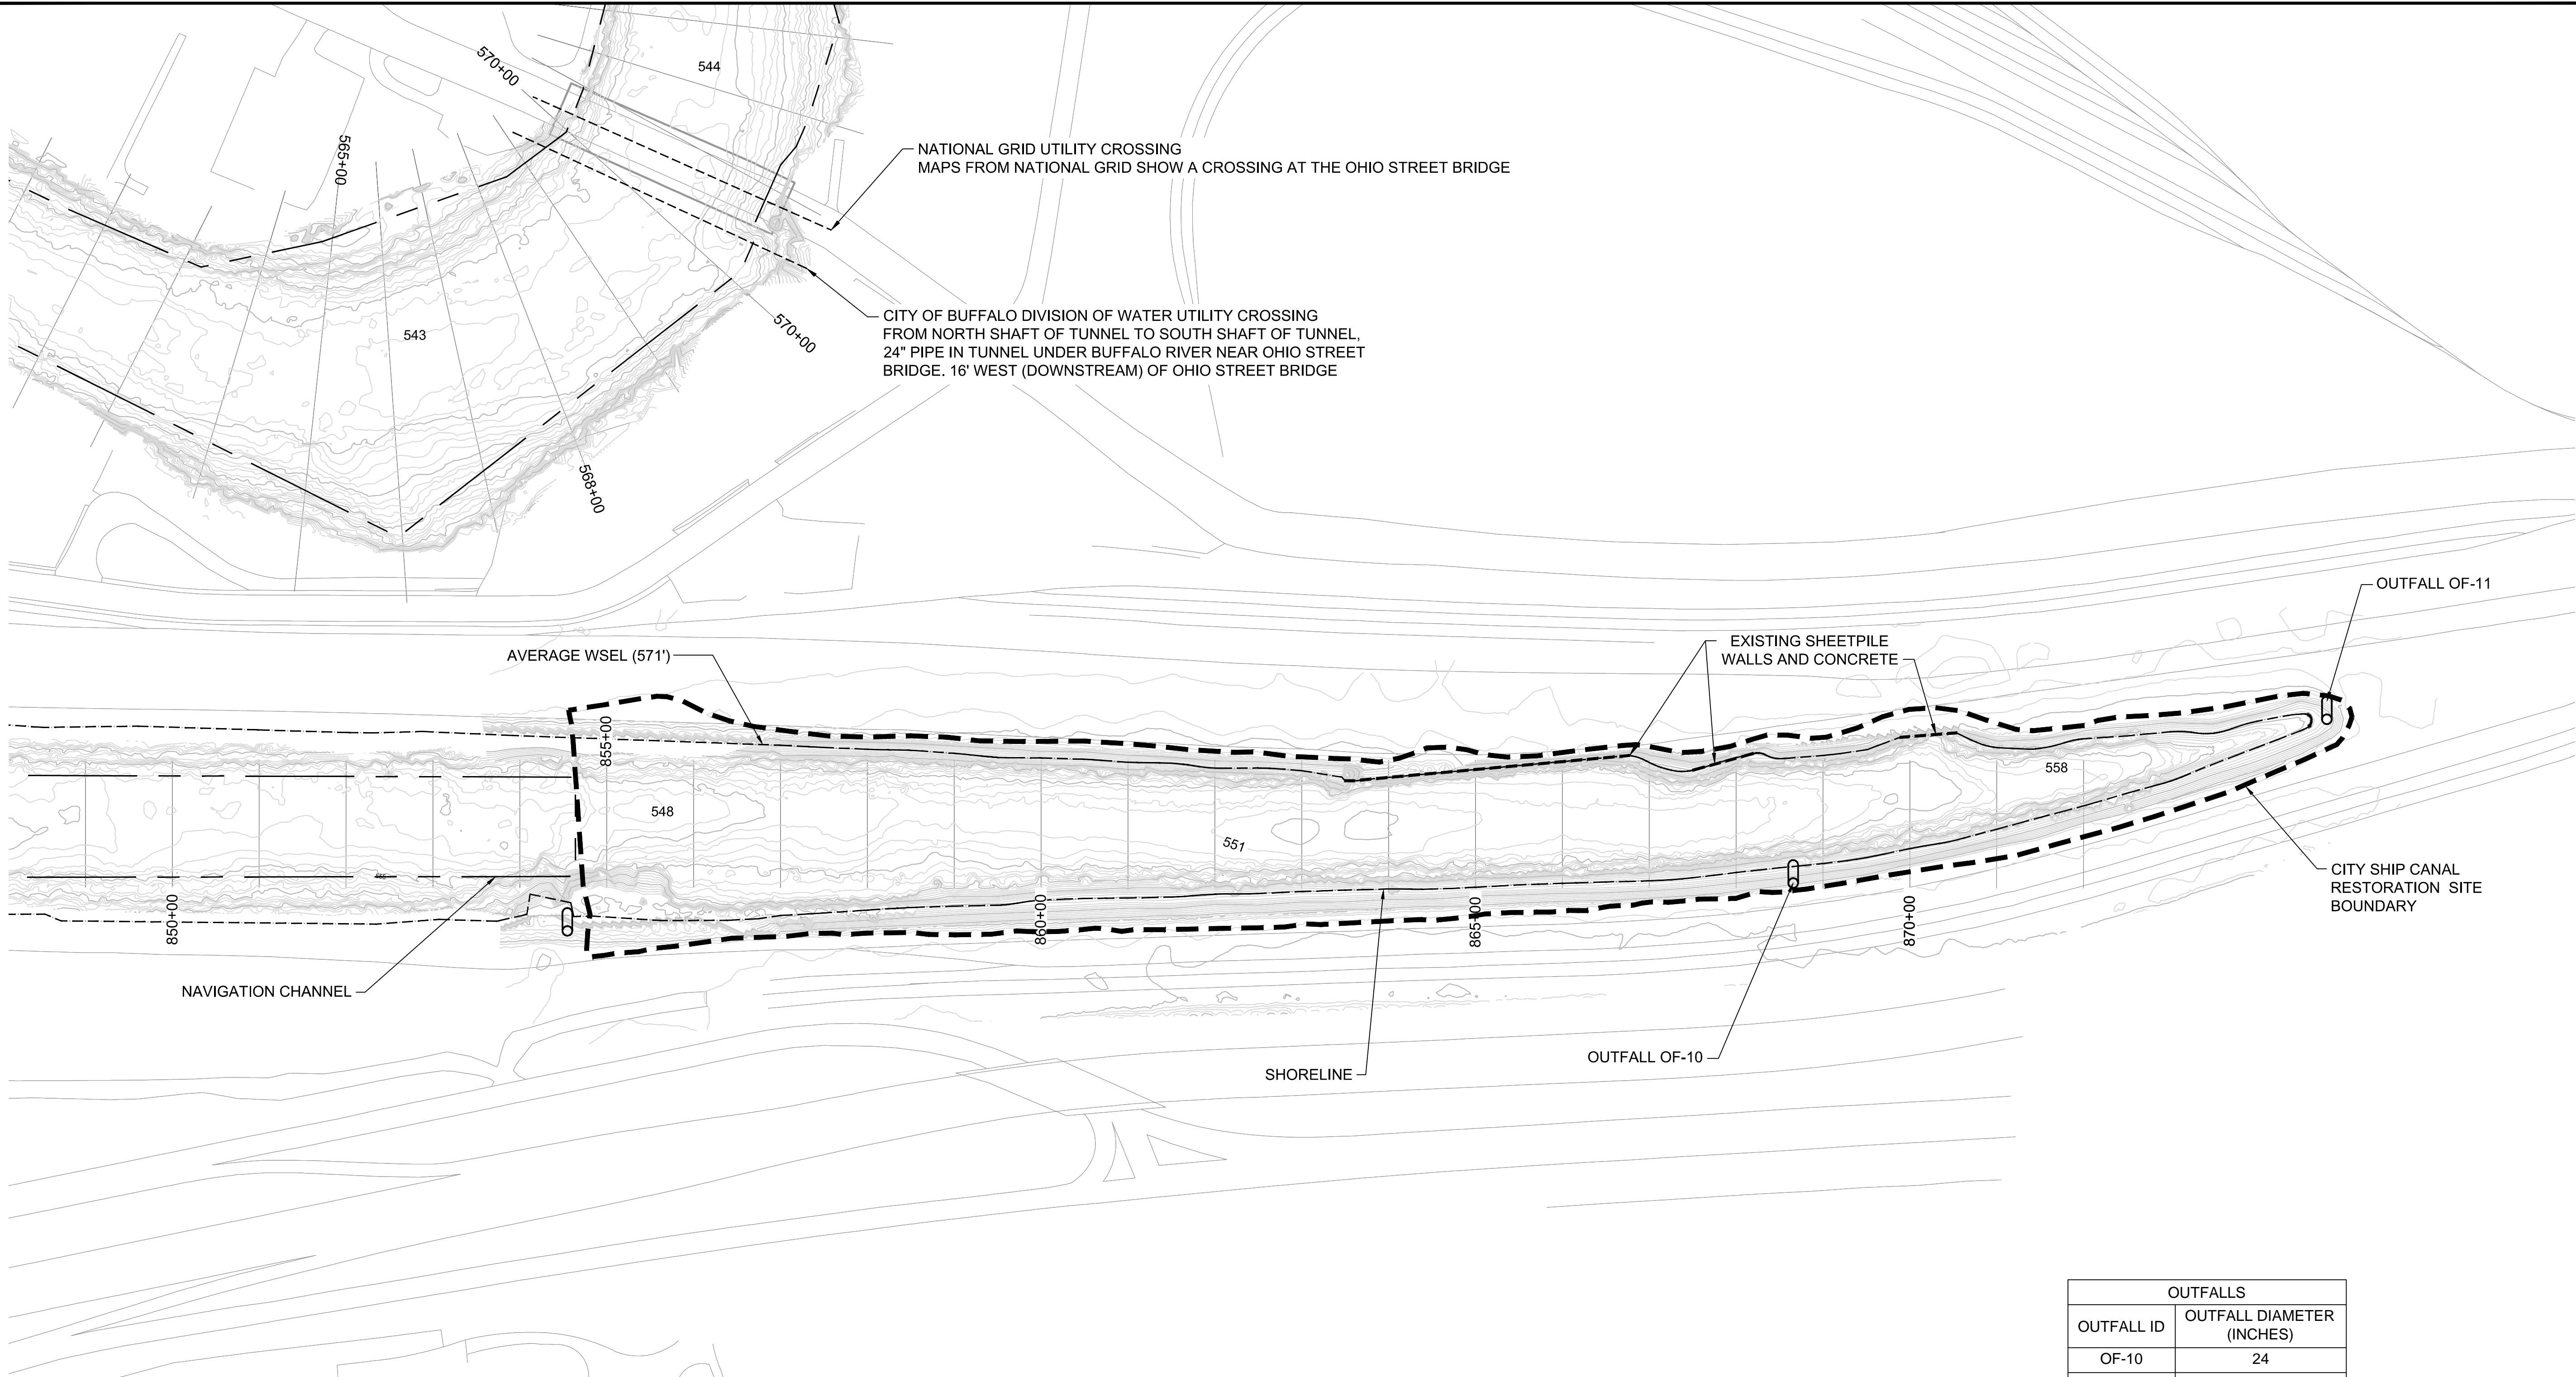
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CHECKED BY: S. BAGNULL  
APPROVED BY: P. DOODY  
DATE: MAY 2014

**BUFFALO RIVER AOC CAPPING AND HABITAT  
RESTORATION**

**EXISTING CONDITIONS - CITY SHIP  
CANAL**


**C-02**

SHEET NO. **05** OF **23**



**NOTES:**

- "EXISTING CONDITIONS": EXISTING CONDITIONS AND ELEVATIONS TAKEN FROM SOURCE IDENTIFIED ON SHEET G-01. NOTE 1.
- CONTRACTOR SHALL CONFIRM ACTUAL BATHYMETRY AND UTILITIES IN OR AFFECTED BY THE WORK PRIOR TO CONSTRUCTION.
- DEBRIS MAY BE ENCOUNTERED IN THE WATER AND ON THE SHORE. DEBRIS THAT INTERFERES WITH CONSTRUCTION SHALL BE REMOVED BY THE CONTRACTOR FOLLOWING APPROVAL OF A DEBRIS REMOVAL AND MANAGEMENT WORK PLAN.
- OUTFALL INFORMATION WAS NOT AVAILABLE FOR ALL OUTFALLS WITHIN THE RESTORATION SITES. PRIOR TO HABITAT RESTORATION ACTIVITIES, THE CONTRACTOR SHALL FIELD VERIFY THE LOCATIONS AND SIZES OF OUTFALLS WITHIN RESTORATION SITES.

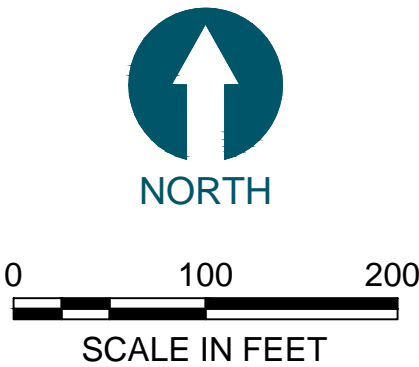

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AT FULL SIZE, IF NOT ONE  
INCH SCALE ACCORDINGLY



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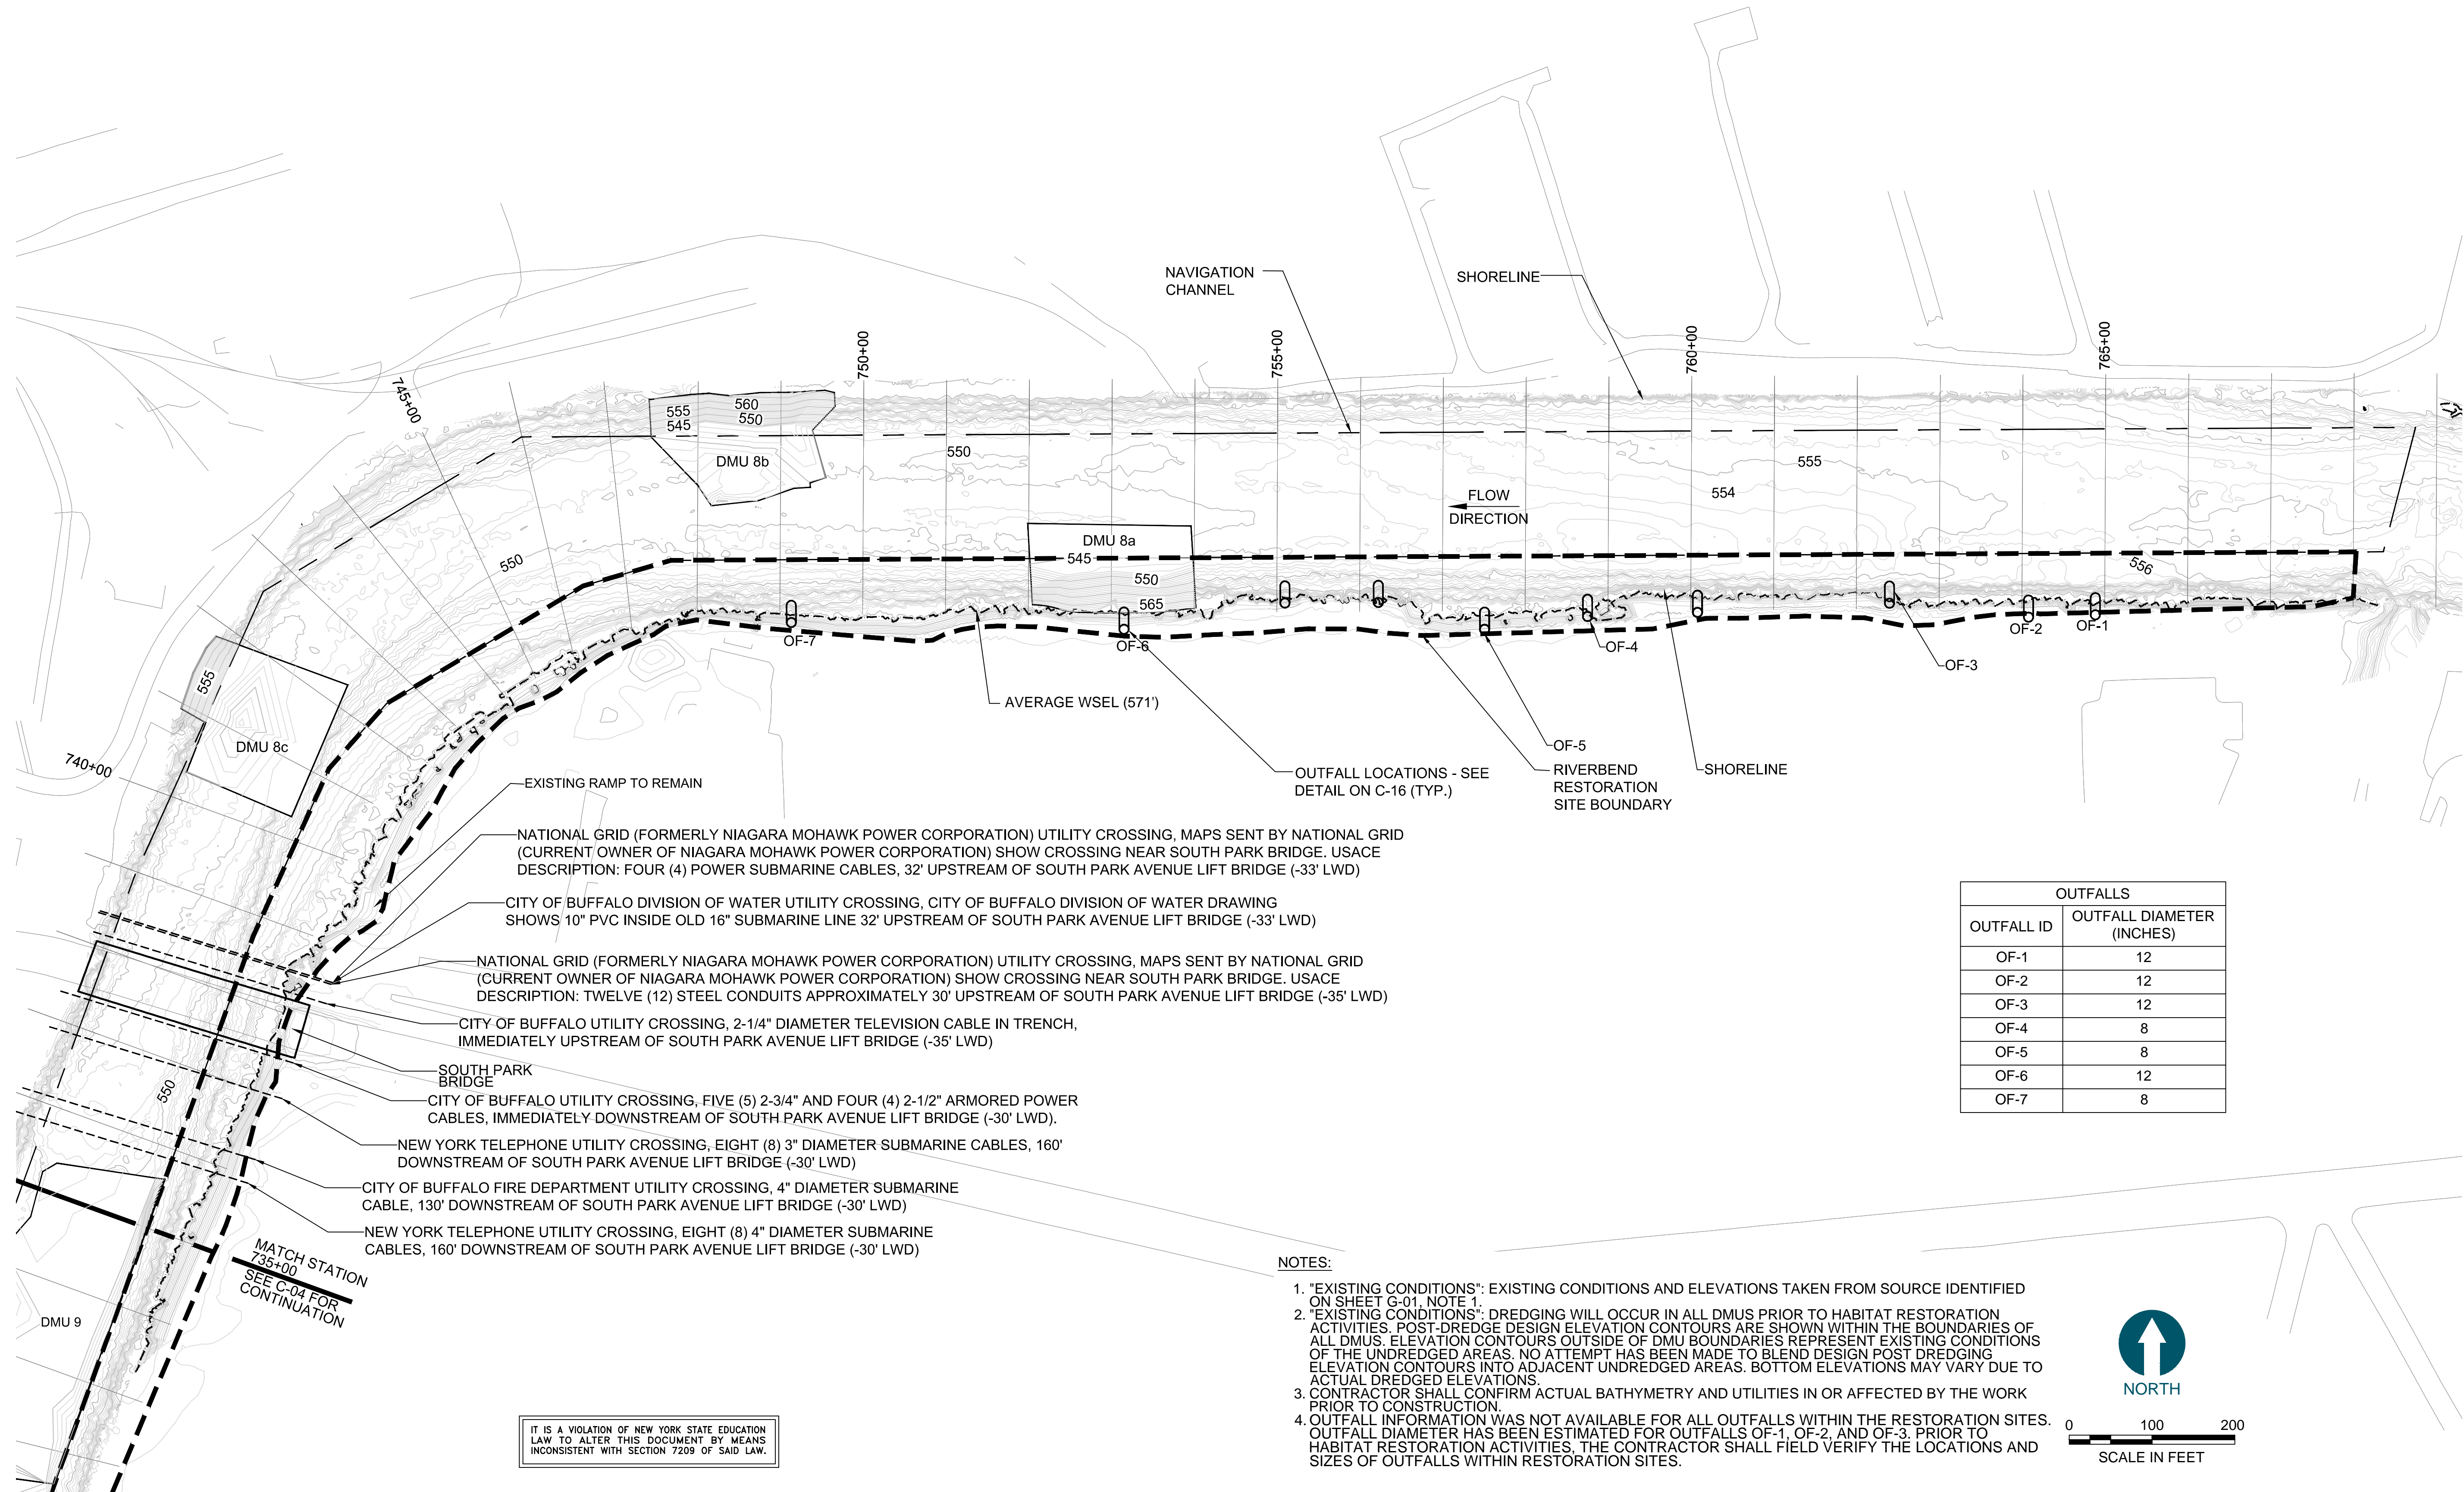
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CHECKED BY: S. BAGNULL  
APPROVED BY: P. DOODY  
DATE: MAY 2014

**BUFFALO RIVER AOC CAPPING AND HABITAT RESTORATION**

**EXISTING CONDITIONS - RIVERBEND (EAST)**

**C-03**

SHEET NO. **06** OF **23**





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OUTFALLS	
OUTFALL ID	OUTFALL DIAMETER (INCHES)
OF-8	6

NOTES:

- "EXISTING CONDITIONS": EXISTING CONDITIONS AND DMU DREDGE DESIGN ELEVATIONS TAKEN FROM SOURCE IDENTIFIED ON SHEET G-01, NOTE 1.
- DREDGING WILL OCCUR IN ALL DMUS PRIOR TO HABITAT RESTORATION ACTIVITIES. POST-DREDGE DESIGN ELEVATION CONTOURS ARE SHOWN WITHIN THE BOUNDARIES OF ALL DMUS. ELEVATION CONTOURS OUTSIDE OF DMU BOUNDARIES REPRESENT PRE-DREGE CONDITIONS OF THE UNDREDGED AREAS. NO ATTEMPT HAS BEEN MADE TO BLEND DESIGN POST DREDGING ELEVATION CONTOURS INTO ADJACENT UNDREDGED AREAS. BOTTOM ELEVATIONS MAY VARY DUE TO ACTUAL DREDGED ELEVATIONS.
- CONTRACTOR SHALL CONFIRM ACTUAL BATHYMETRY AND UTILITIES IN OR AFFECTED BY THE WORK PRIOR TO CONSTRUCTION.
- OUTFALL INFORMATION WAS NOT AVAILABLE FOR ALL OUTFALLS WITHIN THE RESTORATION SITES. PRIOR TO HABITAT RESTORATION ACTIVITIES, THE CONTRACTOR SHALL FIELD VERIFY THE LOCATIONS AND SIZES OF OUTFALLS WITHIN RESTORATION SITES.
- CONTRACTOR IS DIRECTED TO KEEP ALL SPUDS AND ANCHORS AT LEAST 25 FEET FROM ARCHEOLOGICAL POINT BF-5.


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DATE: MAY 2014

**BUFFALO RIVER AOC CAPPING AND HABITAT  
RESTORATION**

**EXISTING CONDITIONS - BUFFALO  
COLOR PENINSULA AND RIVERBEND  
(WEST)**

SHEET NO. **07** OF **23**



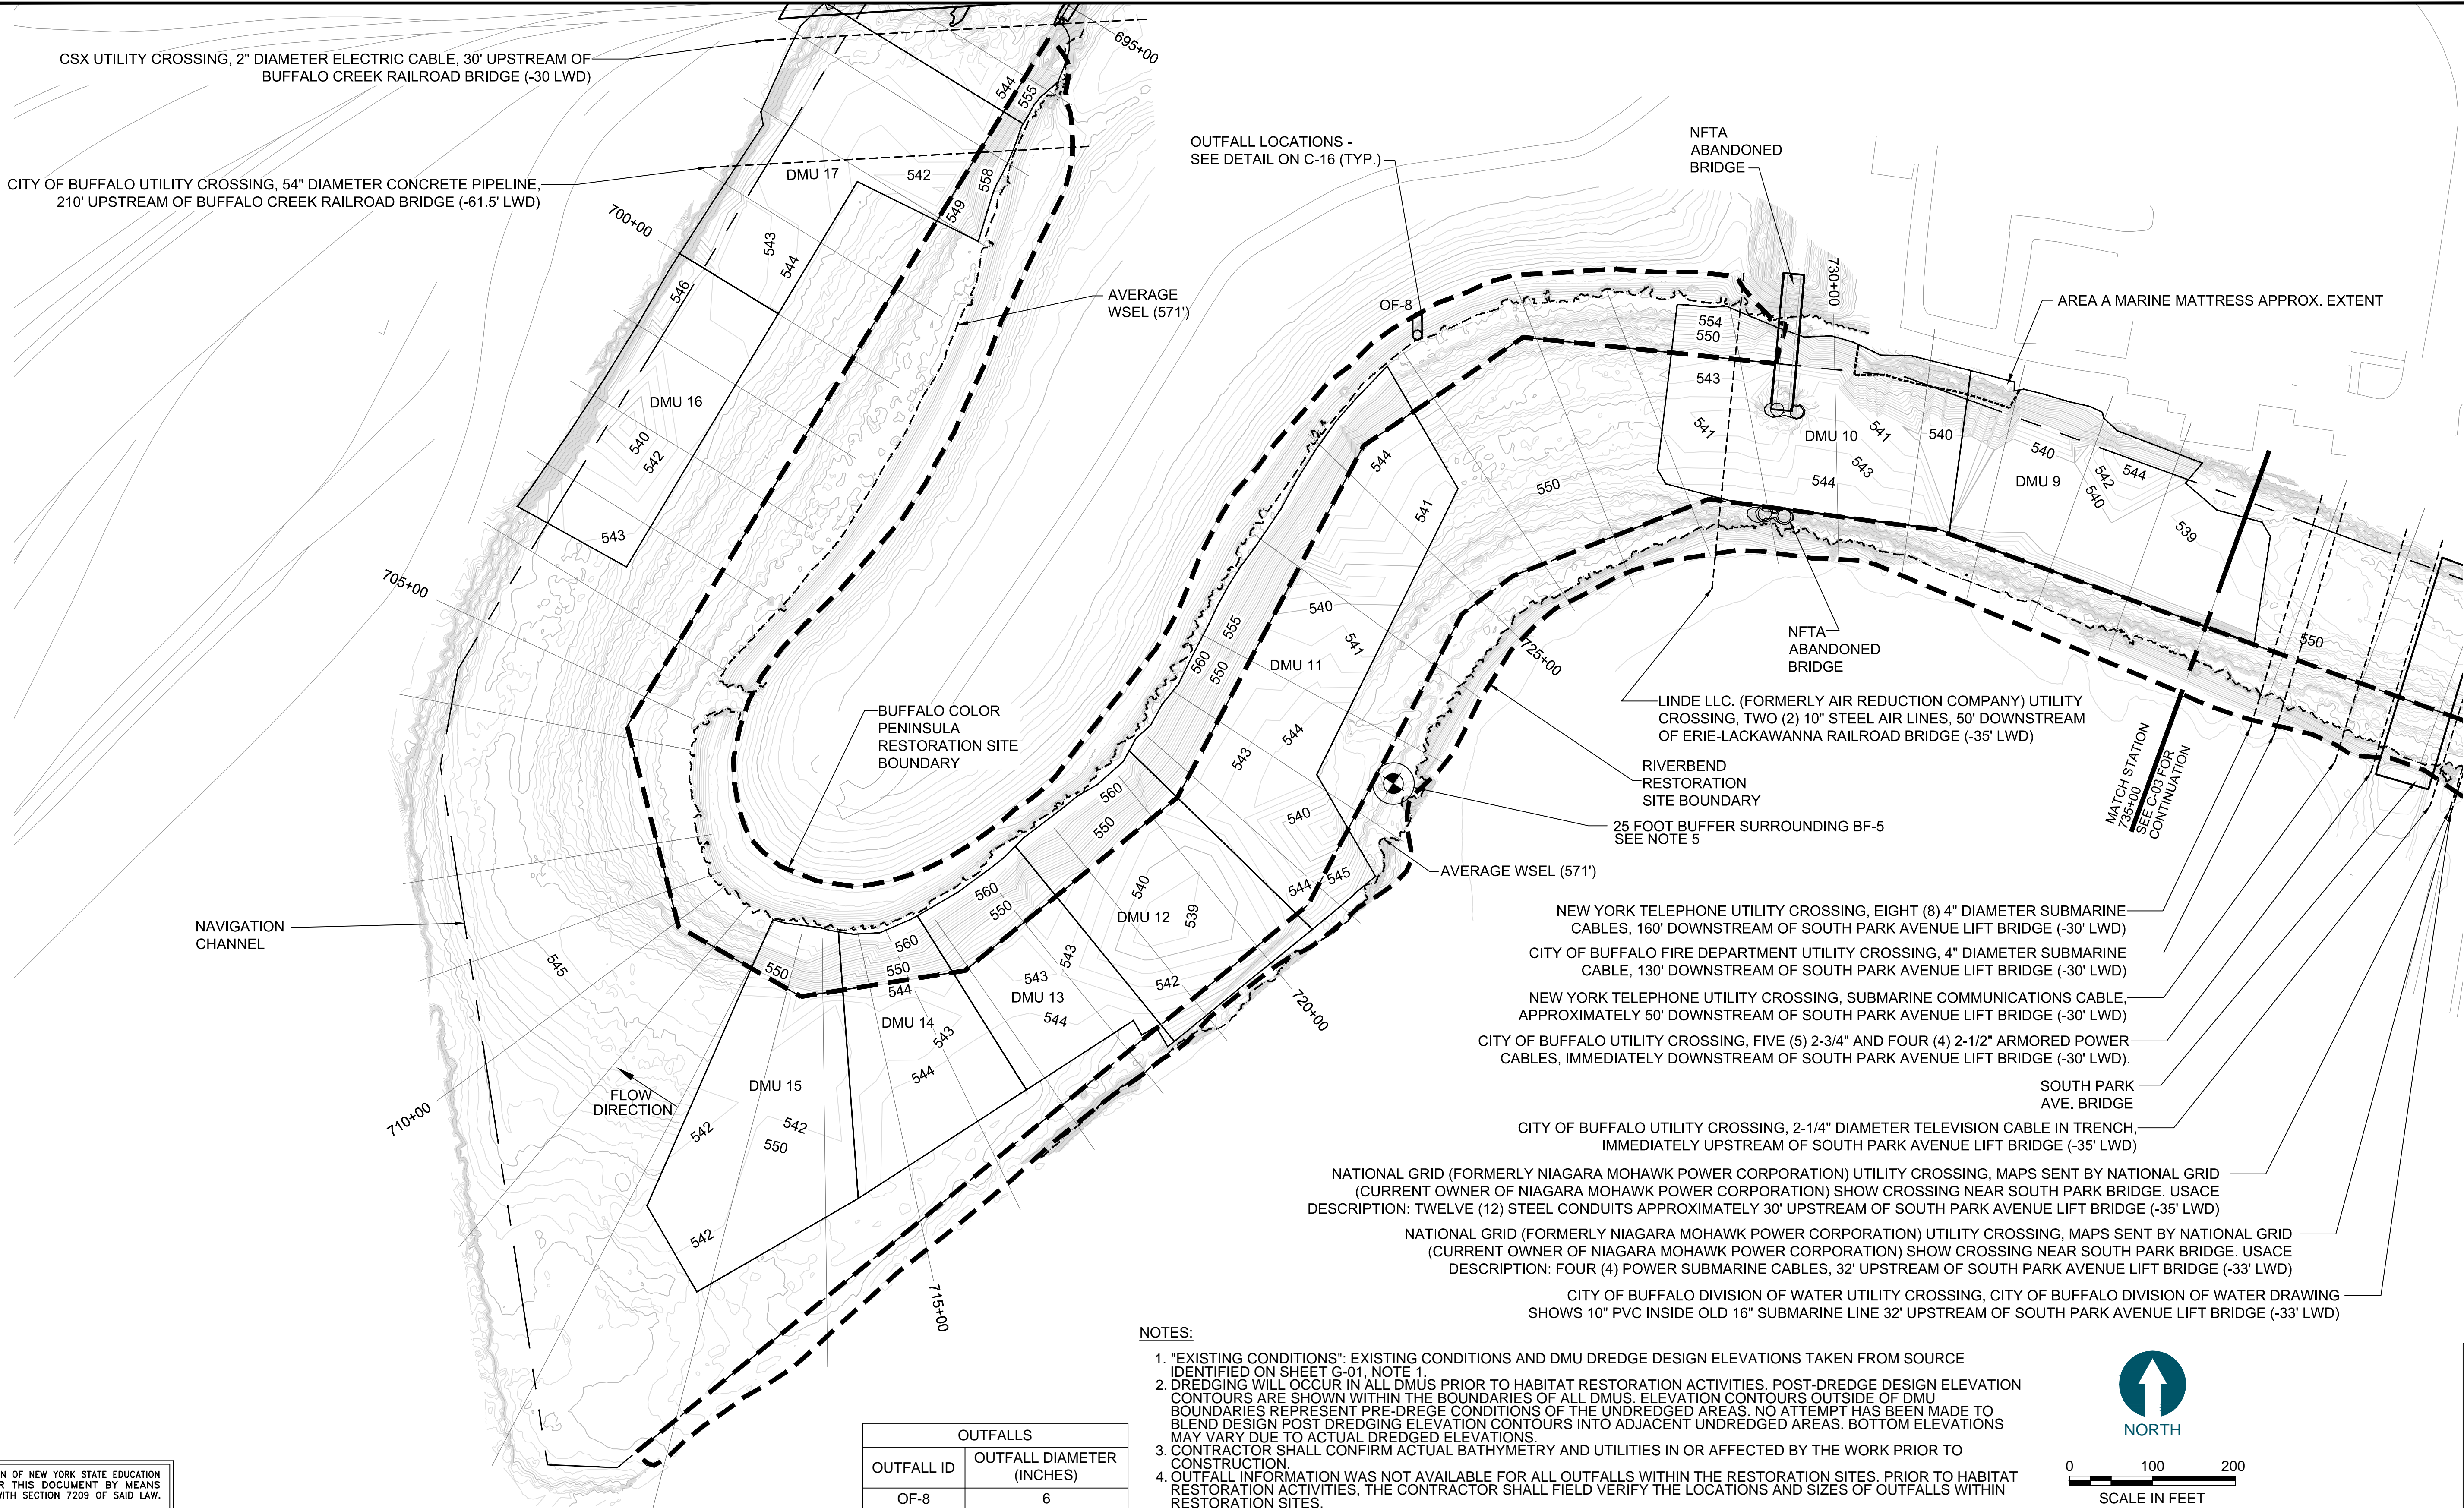


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NOTES:

1. "EXISTING CONDITIONS": EXISTING CONDITIONS AND DMU DREDGE DESIGN ELEVATIONS TAKEN FROM SOURCE IDENTIFIED ON SHEET G-01, NOTE 1.
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OUTFALLS	
OUTFALL ID	OUTFALL DIAMETER (INCHES)
OF-9	UNKNOWN

REVISIONS				
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BUFFALO RIVER AOC CAPPING AND HABITAT RESTORATION


EXISTING CONDITIONS - OHIO STREET SHORELINE

C-05

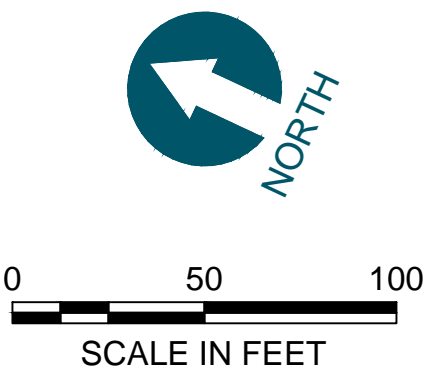SHEET NO. 08 OF 23



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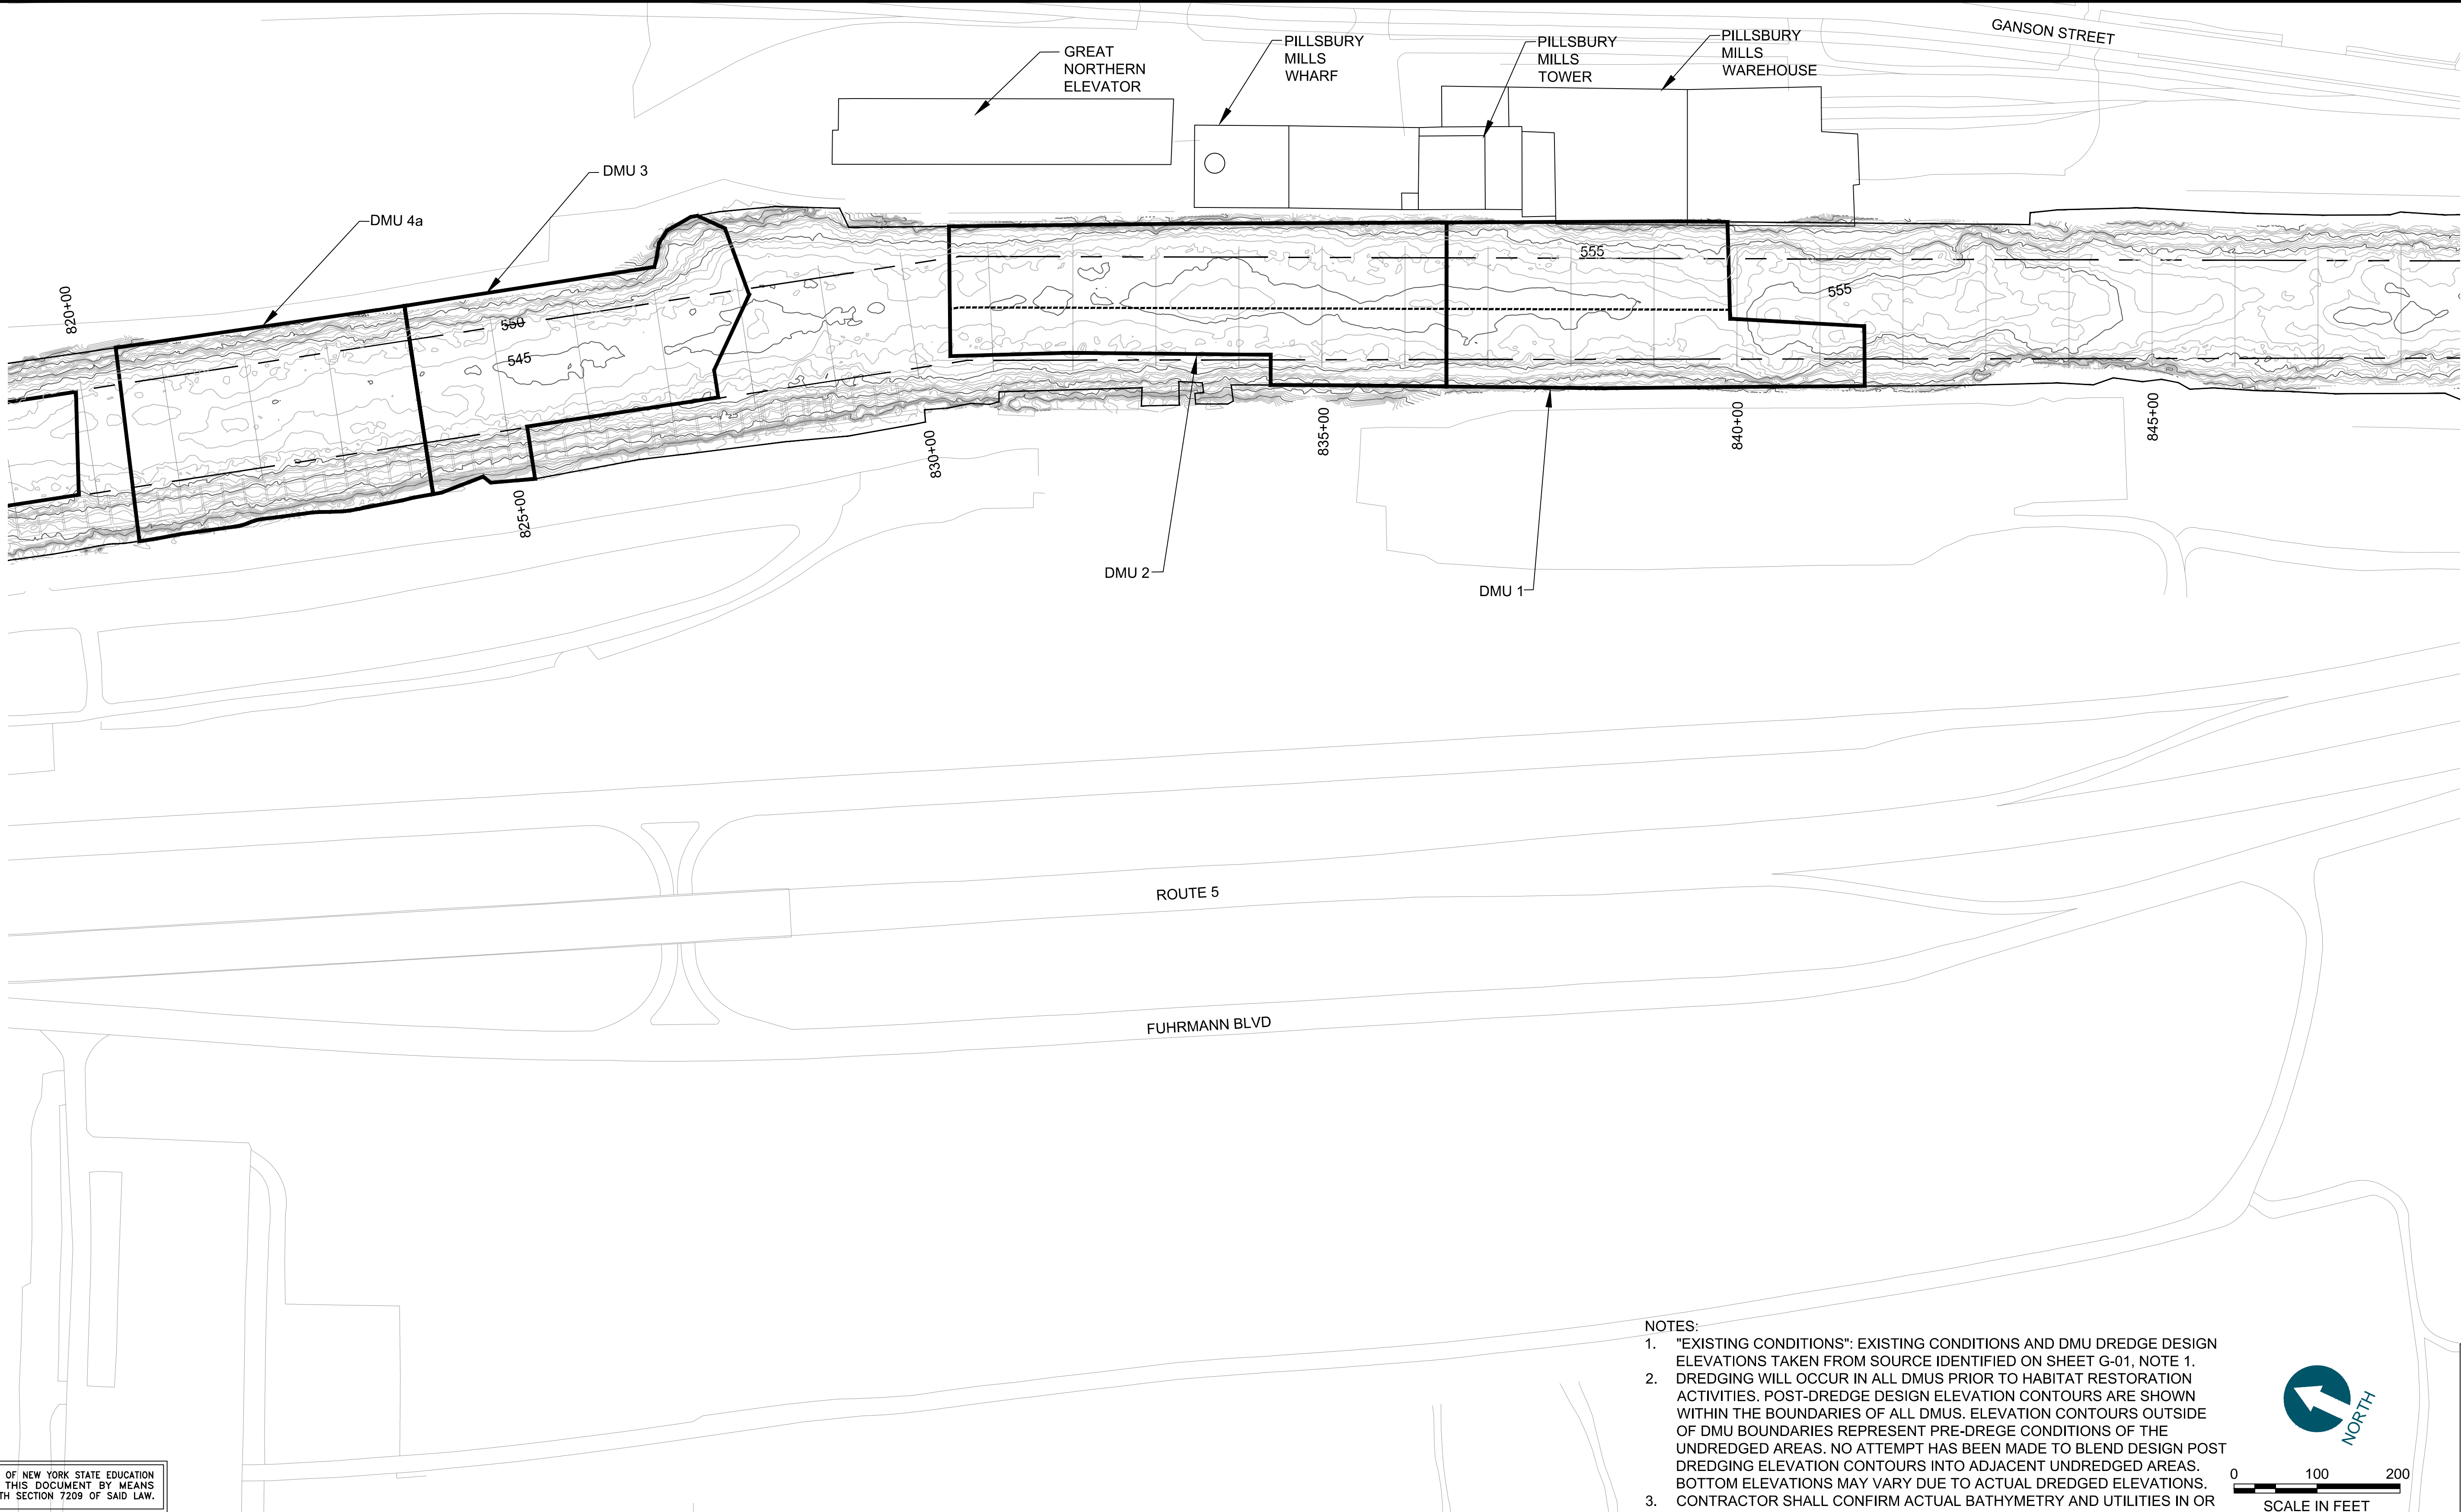
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APPROVED BY: P. DOODY  
DATE: MAY 2014

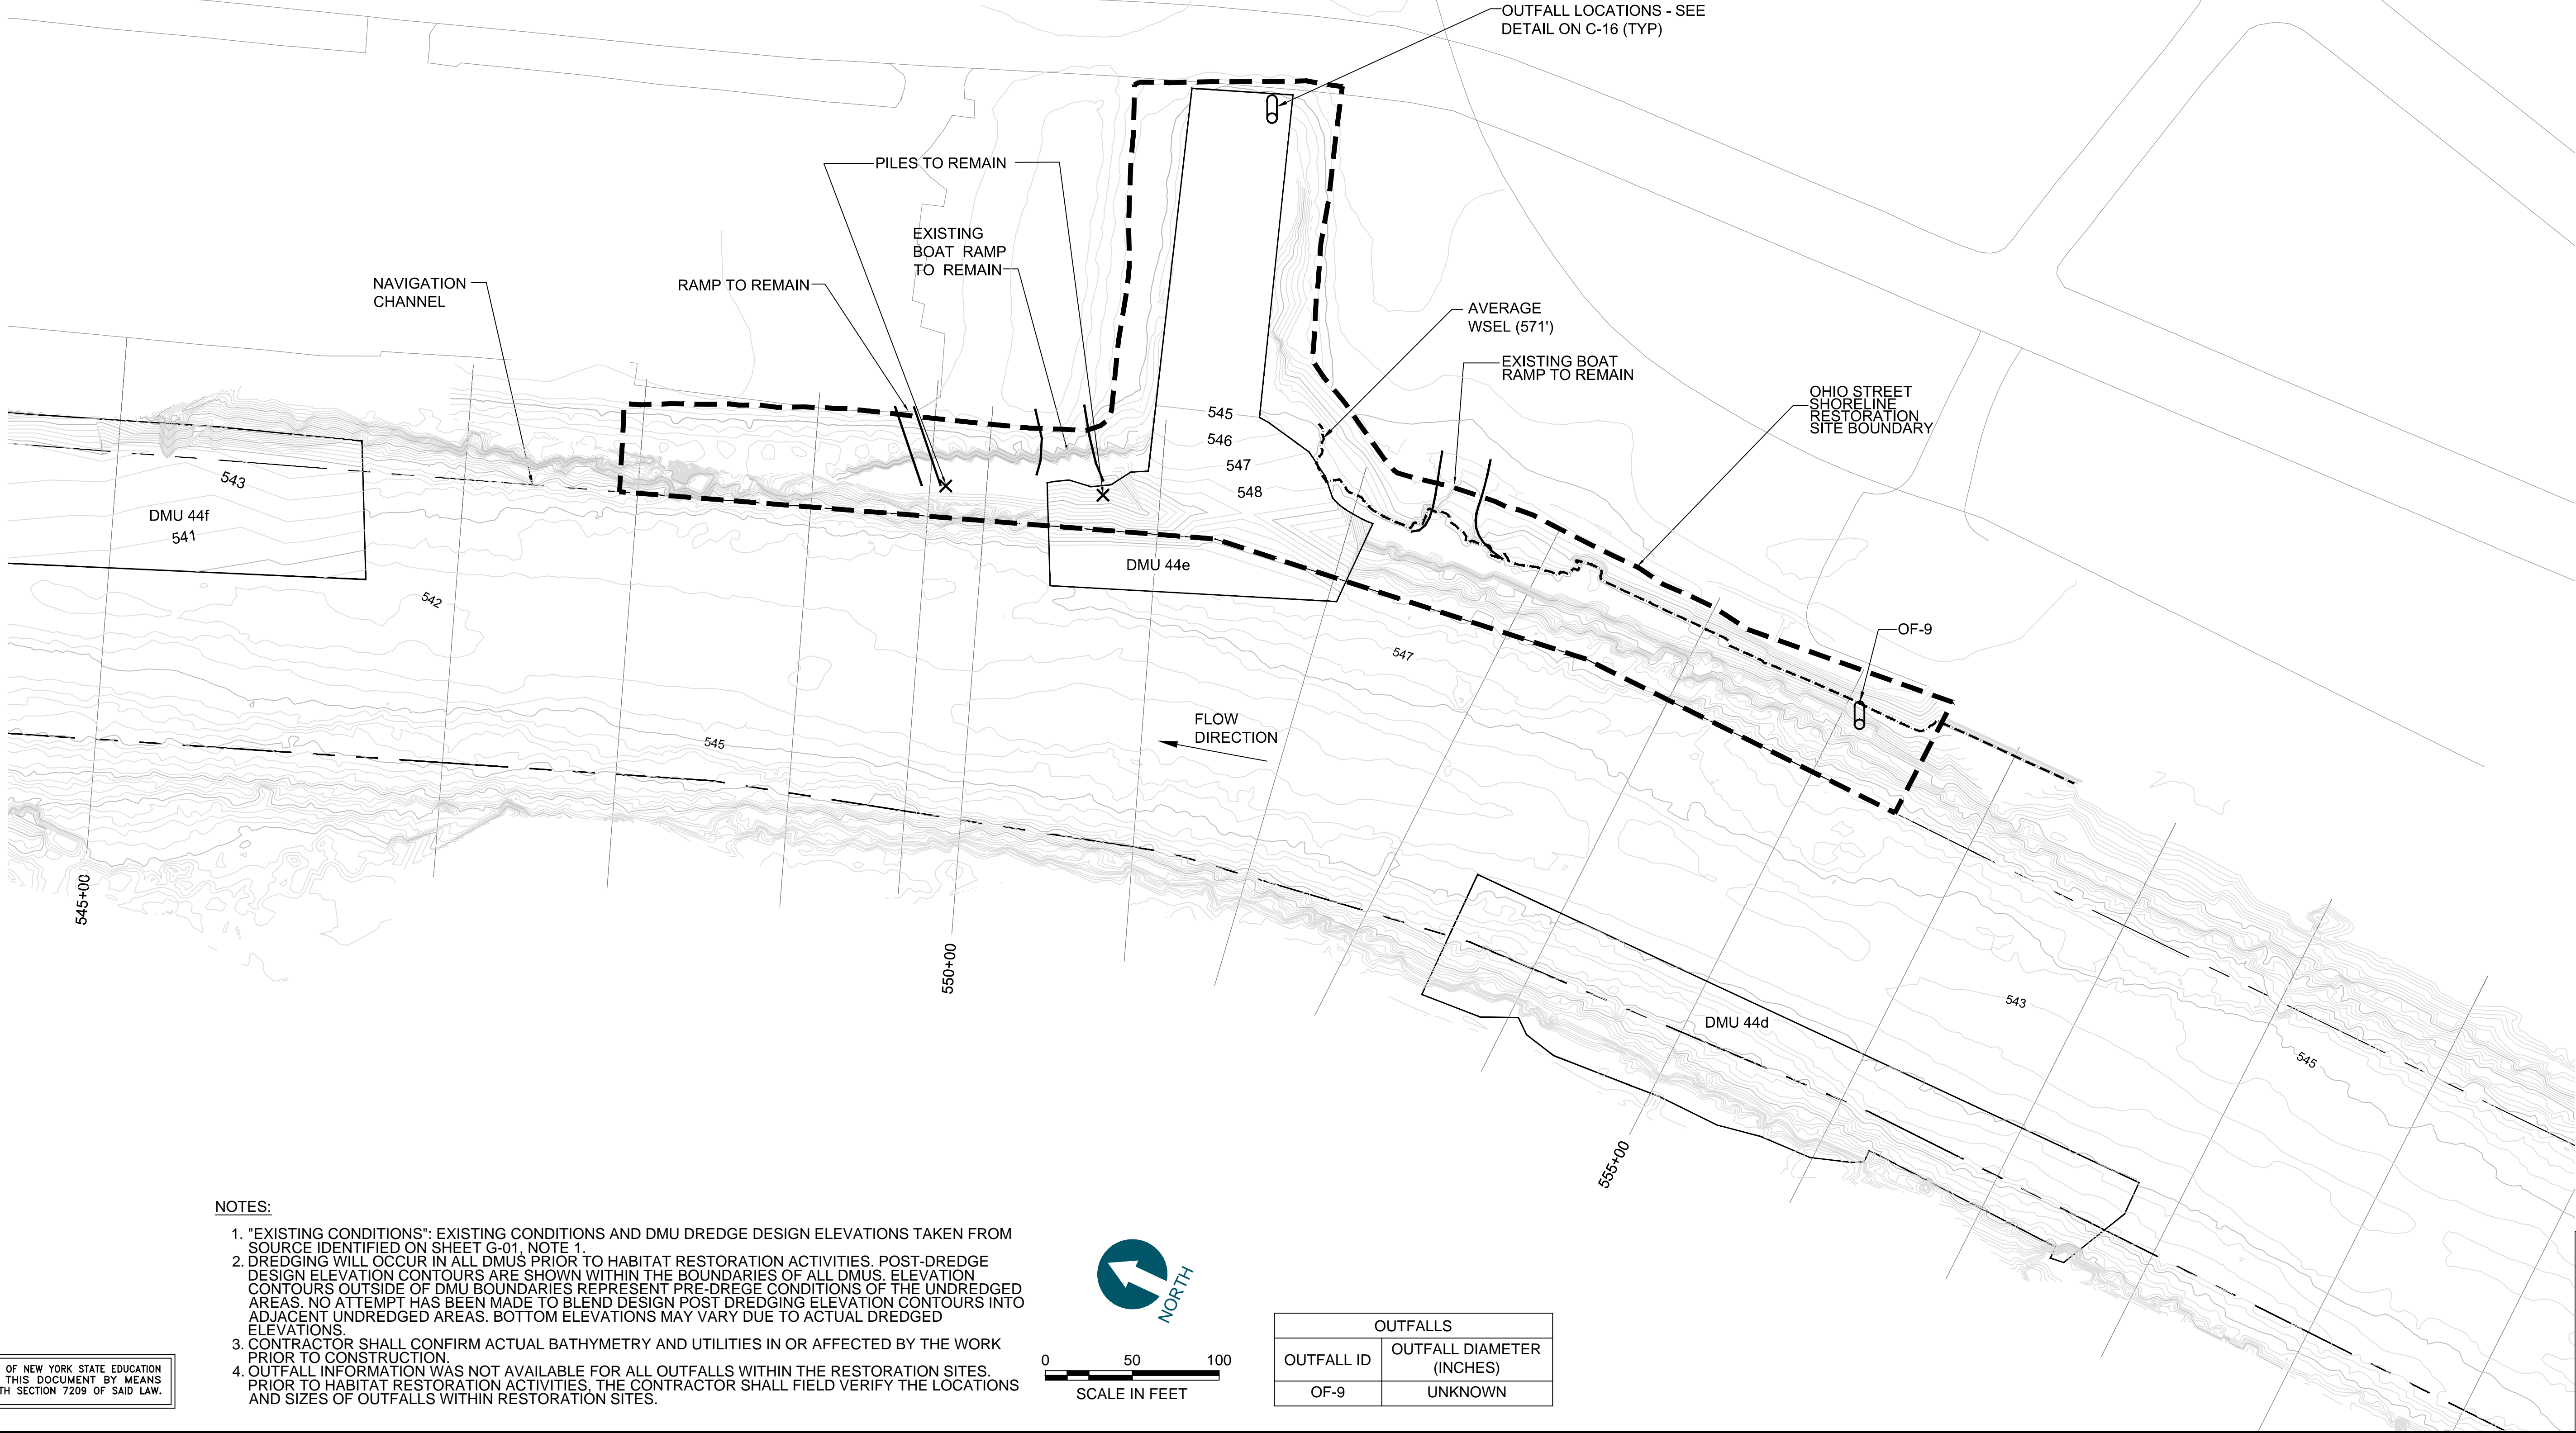**BUFFALO RIVER AOC CAPPING AND HABITAT  
RESTORATION**

**EXISTING CONDITIONS - ADM  
PILLSBURY**

**C-06**

SHEET NO. **09** OF **23**




- NOTES:
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  3. CONTRACTOR SHALL CONFIRM ACTUAL BATHYMETRY AND UTILITIES IN OR AFFECTED BY THE WORK PRIOR TO CONSTRUCTION.




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May 19, 2014 1:07pm chevet

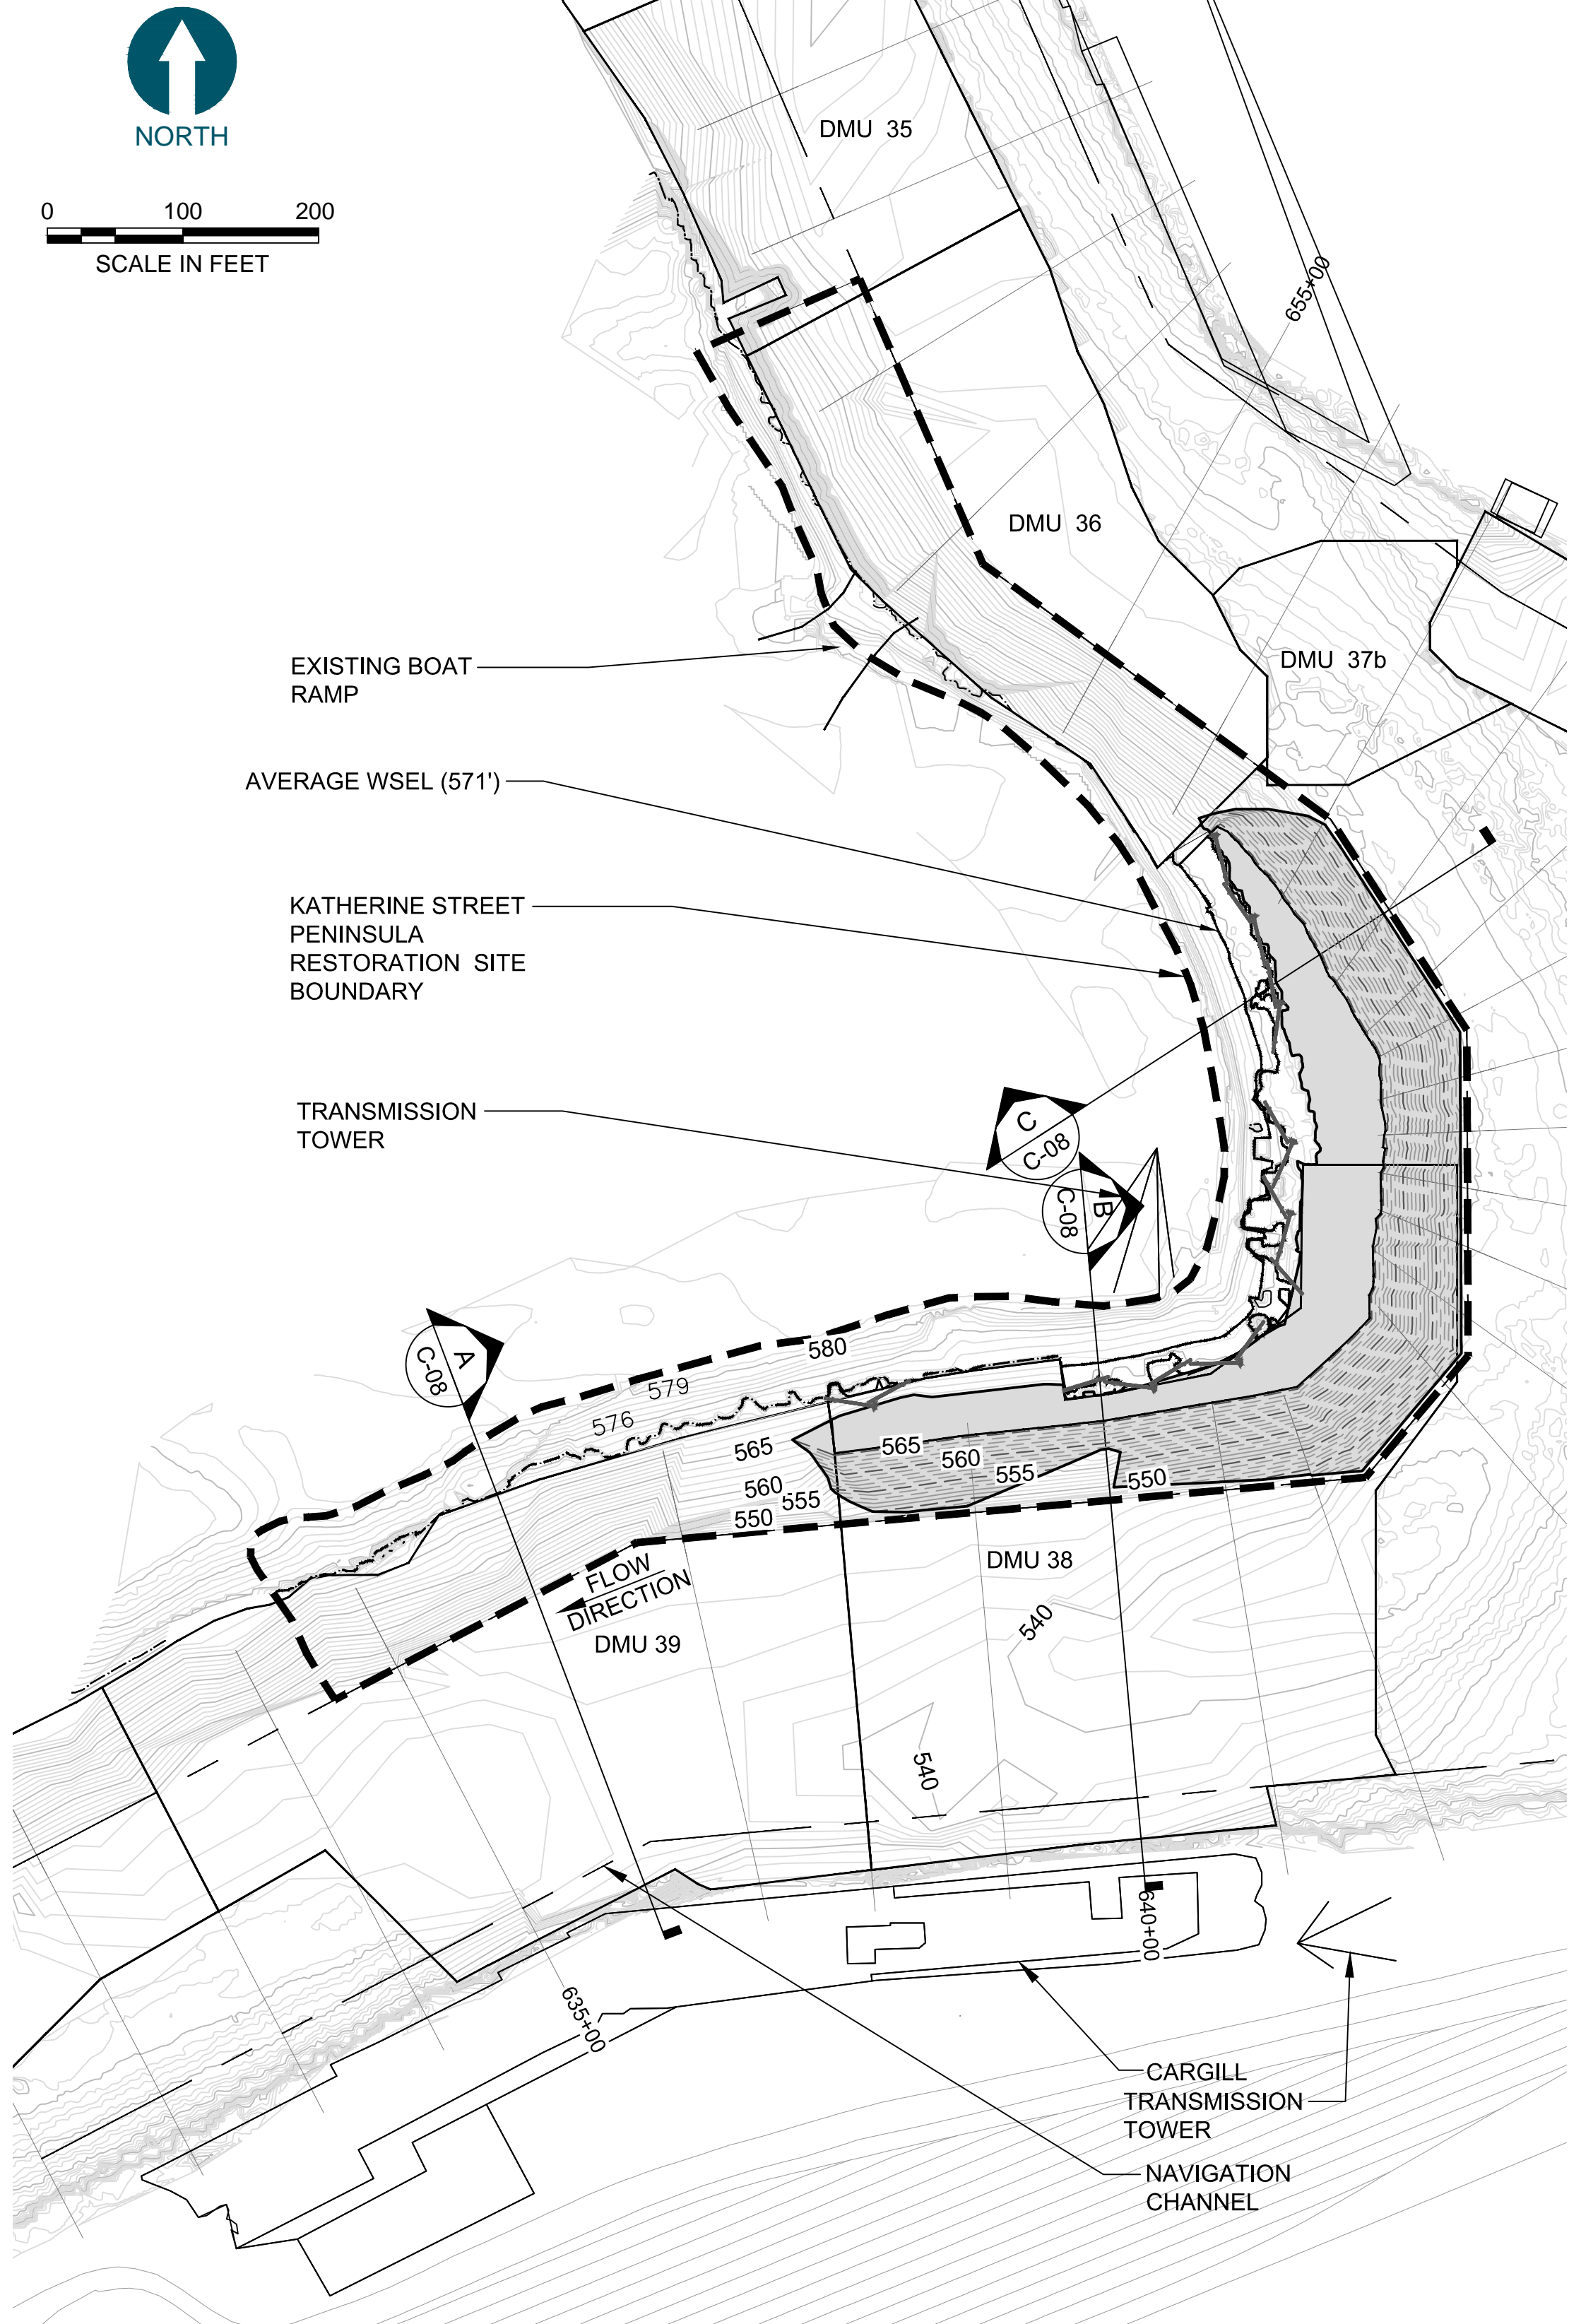

GRADING/BACKFILL PLAN

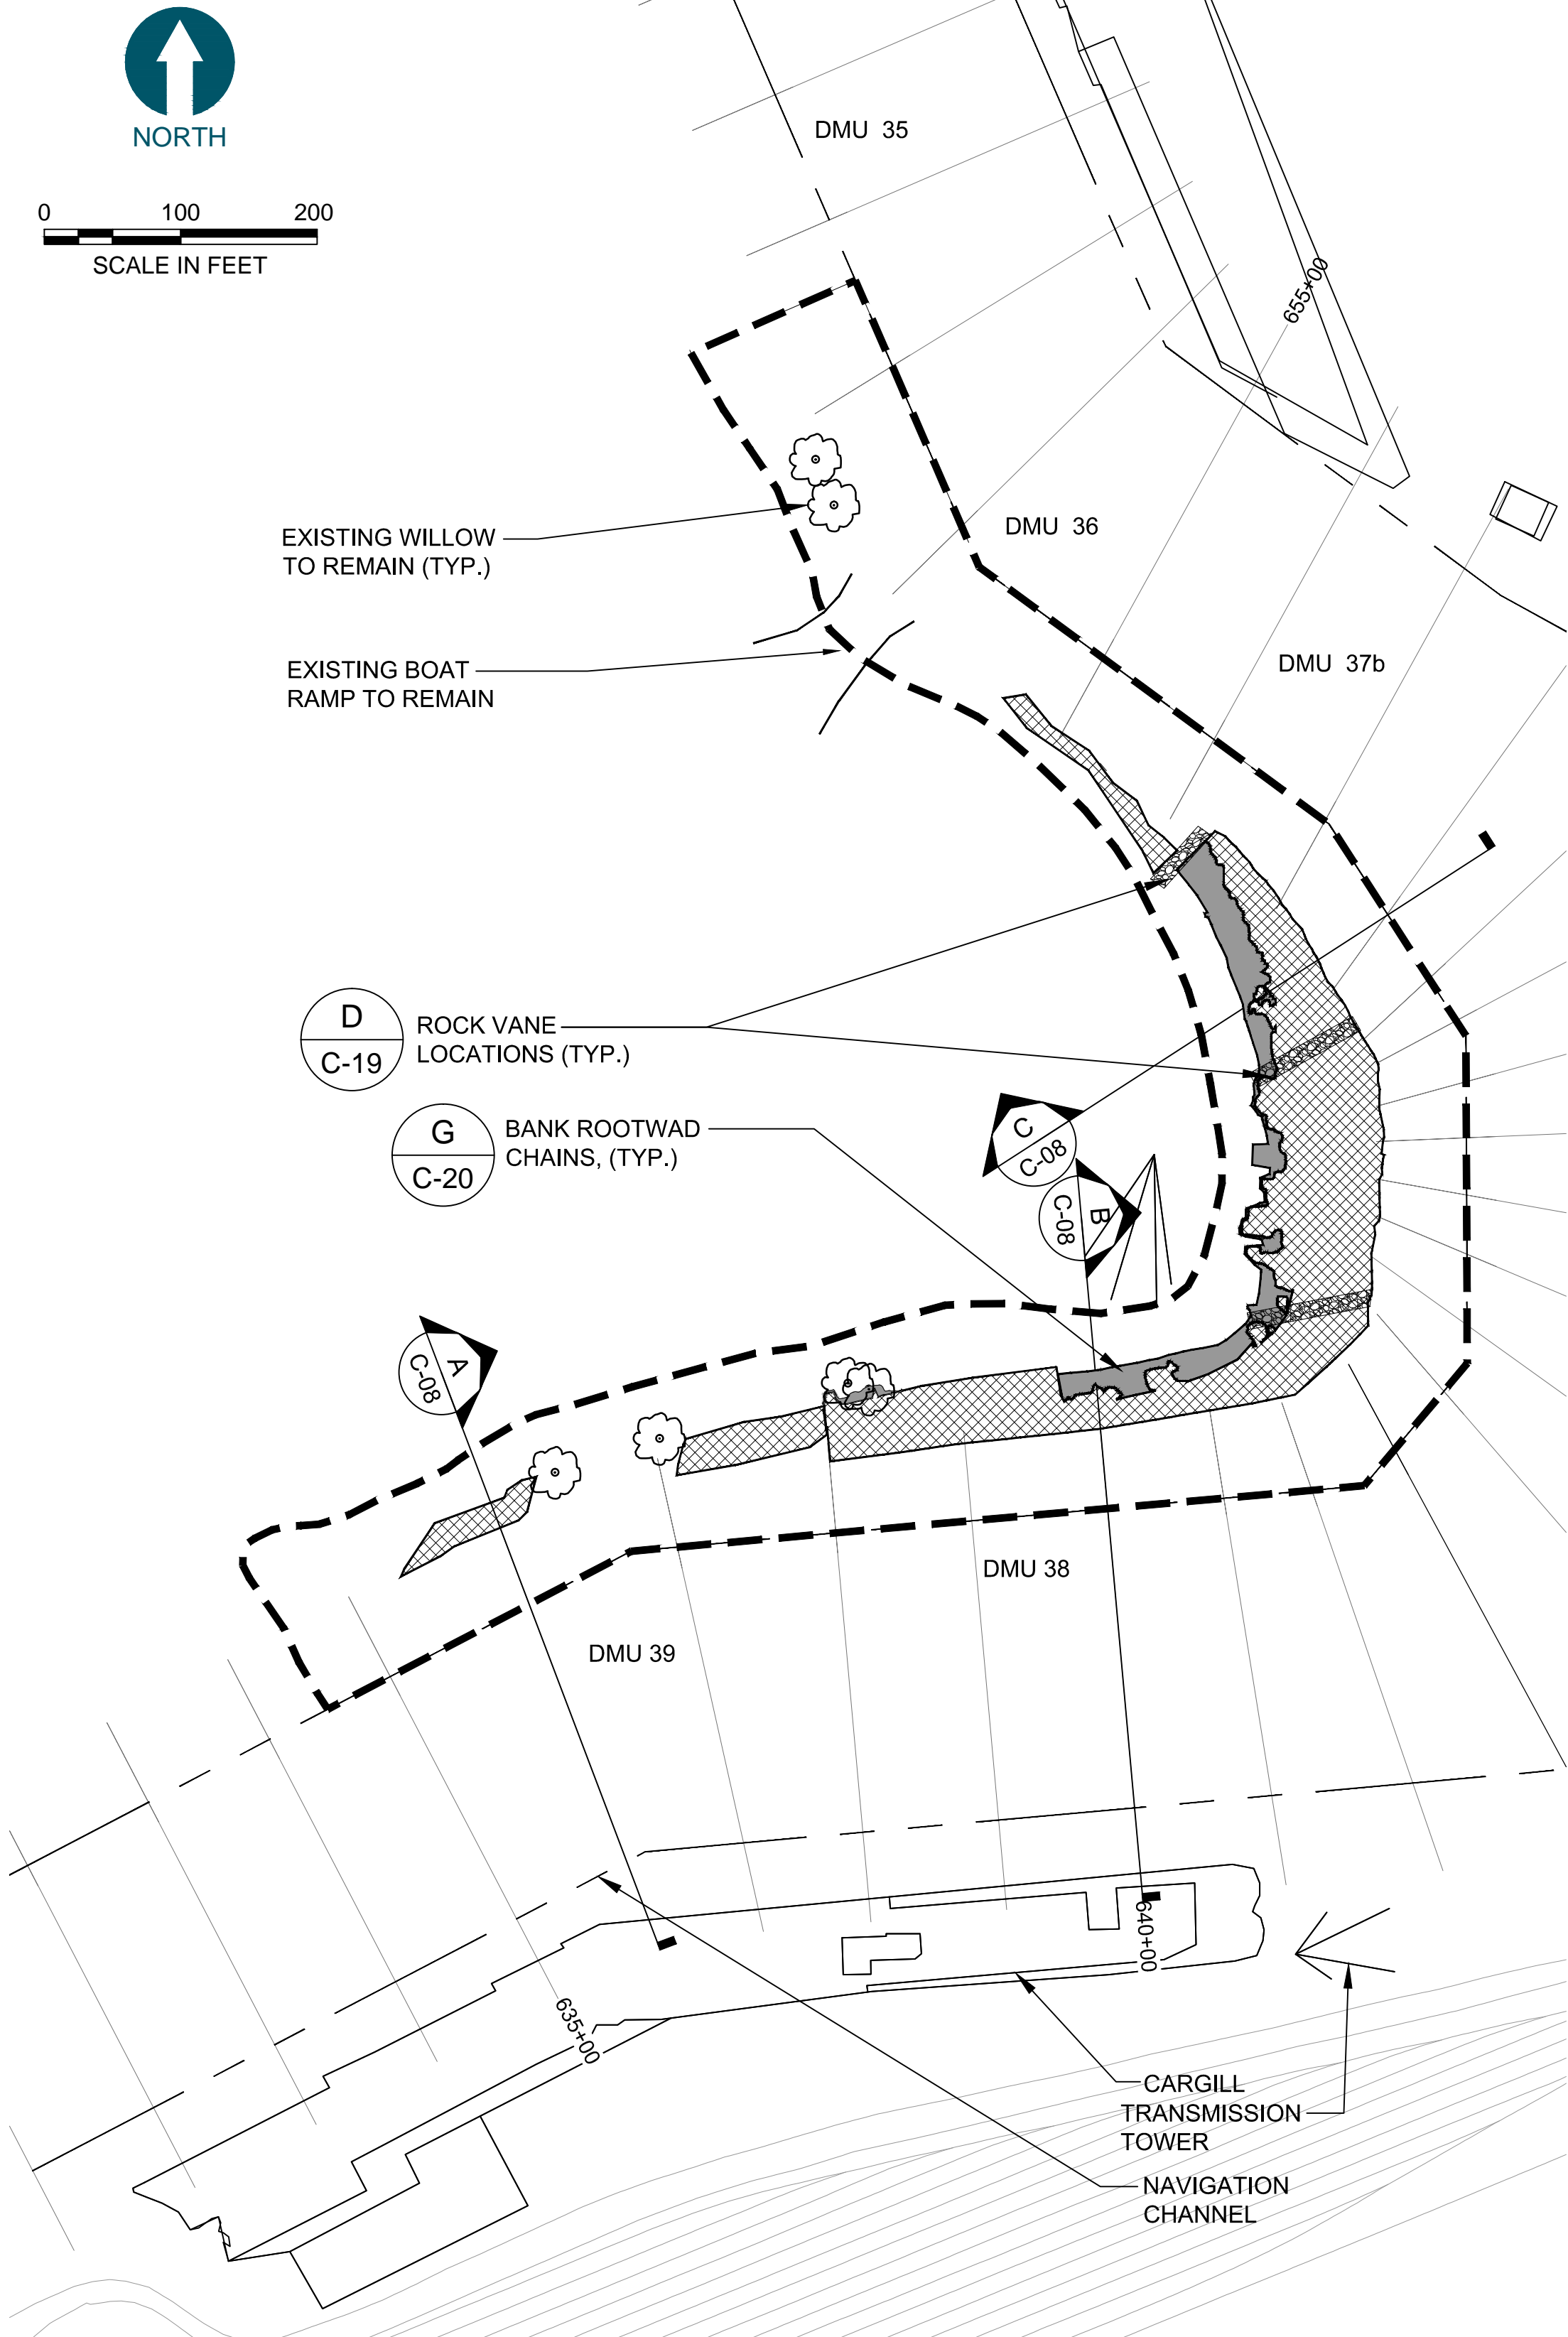

HABITAT RESTORATION PLAN

- LEGEND
- RESTORATION AREA BOUNDARY
  - AVERAGE WSEL (571')
  - NAVIGATION CHANNEL
  - SUBMERGED AQUATIC VEGETATION (SAV) PLANTING AREA
  - EMERGENT VEGETATION (EV) PLANTING AREA
  - HABITAT SUBGRADE MATERIAL
  - ROCK VANE
  - PROPOSED BANK ROOTWAD CHAIN

- NOTES
- ALL TREES GREATER THAN 2.0 FEET DBH SHALL REMAIN. ALL EXCEPTIONS MUST BE APPROVED BY THE ENGINEER.
  - FOR DETAILS ON THE VARIOUS PLANTING TYPES (SAV & EV), SEE G-01. REFER TO SPECIFICATION FOR PLANT PREPARATION AND PLANTING EXECUTION. THE UPLAND LIMIT OF THE EV PLANTINGS IS AT 571' ELEVATION. FIELD VERIFY THE 571' ELEVATION.
  - HABITAT SUBGRADE MATERIAL SHALL BE PLACED FOLLOWING DREDGING TO ESTABLISH APPROPRIATE ELEVATIONS FOR SAV PLANTINGS ALONG THE SHORELINE. ACTUAL FILL REQUIRED SHALL BE BASED ON CONTRACTOR'S PRE-RESTORATION SURVEY.
  - NO MATERIAL MAY BE PLACED IN NAVIGATION CHANNEL OR WITHIN 5' OFFSET FROM NAVIGATION CHANNEL.

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DESIGNED BY: J. GAFFNEY  
DRAWN BY: C. HEWETT  
CHECKED BY: M. REEMTS  
APPROVED BY: P. DOODY  
DATE: MAY 2014

**BUFFALO RIVER AOC CAPPING AND HABITAT RESTORATION**

**HABITAT RESTORATION PLAN VIEW - KATHERINE STREET PENINSULA**


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SHEET NO. 10 OF 23


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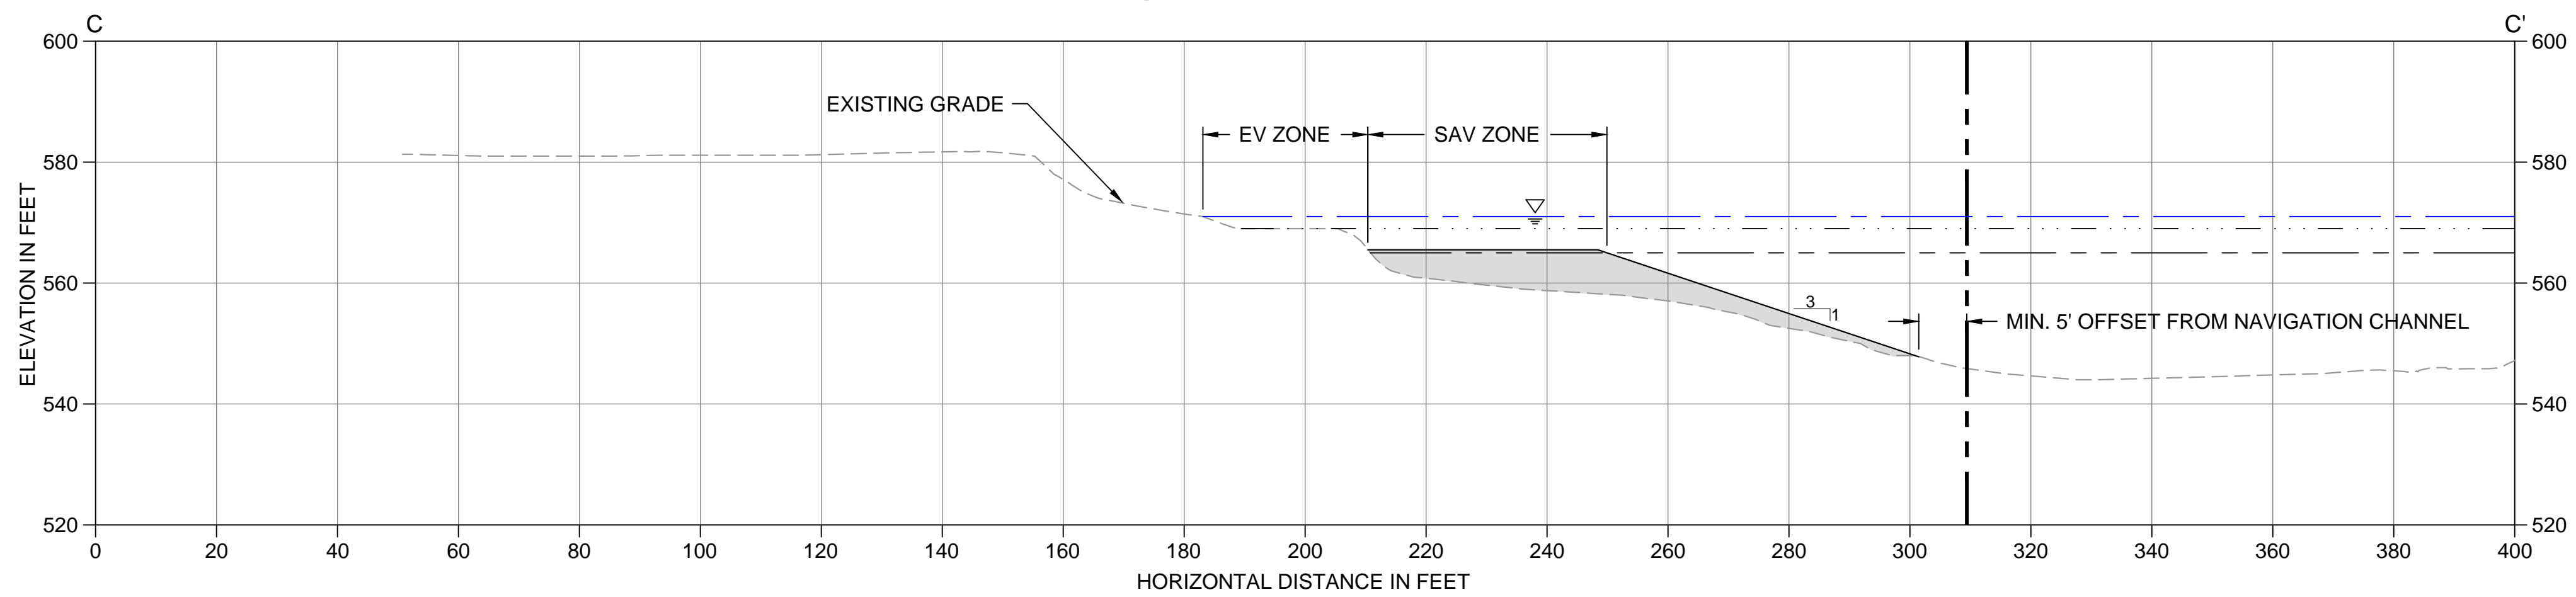
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**A**  
SECTION A-A'  
C-07 SCALE: 1" = 20'




**B**  
SECTION B-B'  
C-07 SCALE: 1" = 20'

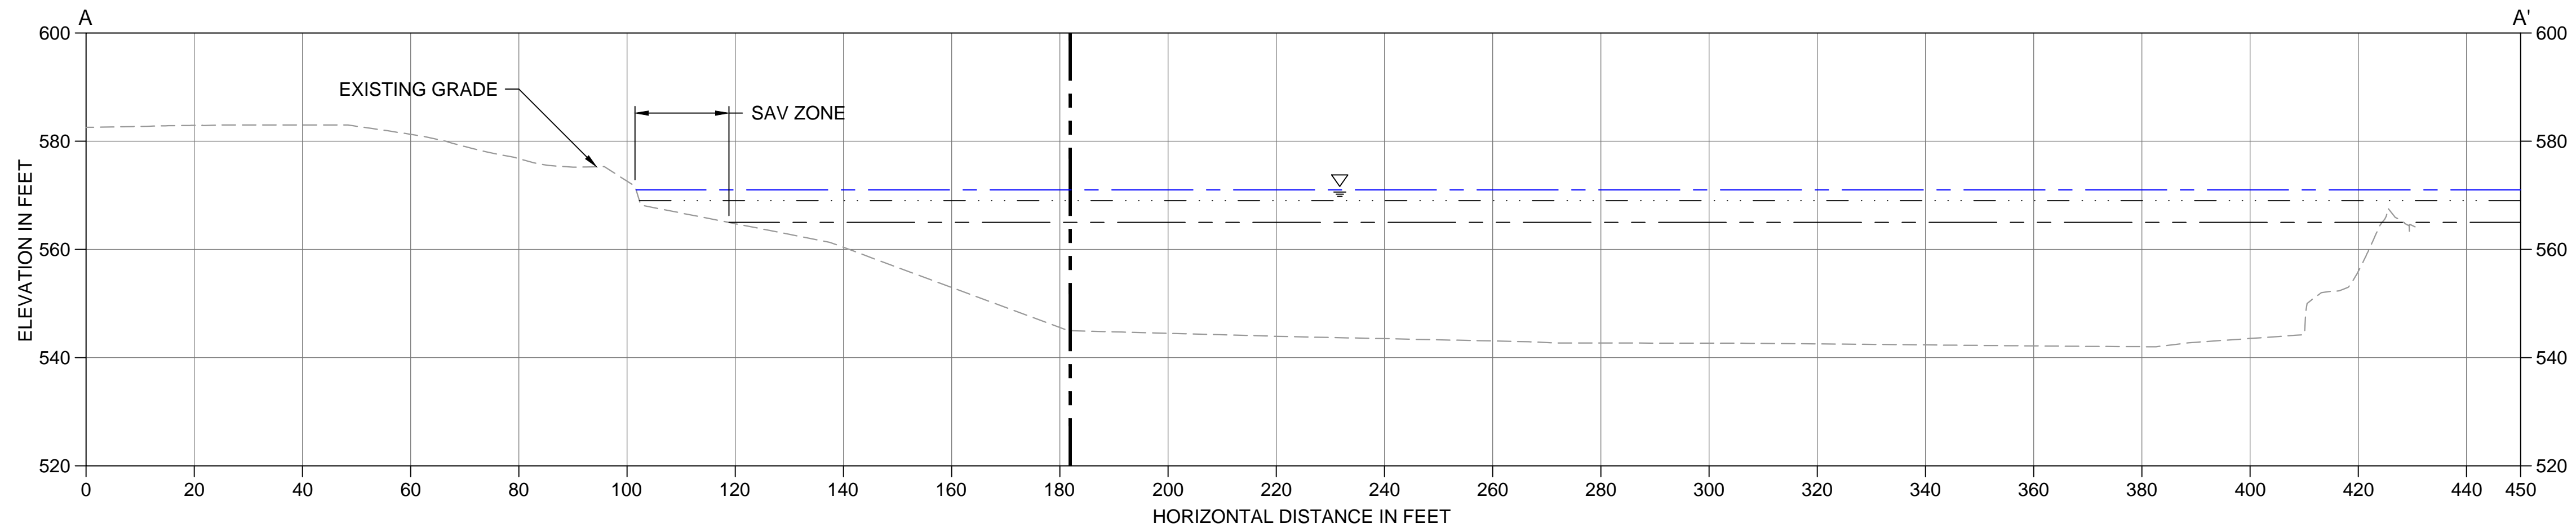

**C**  
SECTION C-C'  
C-07 SCALE: 1" = 20'

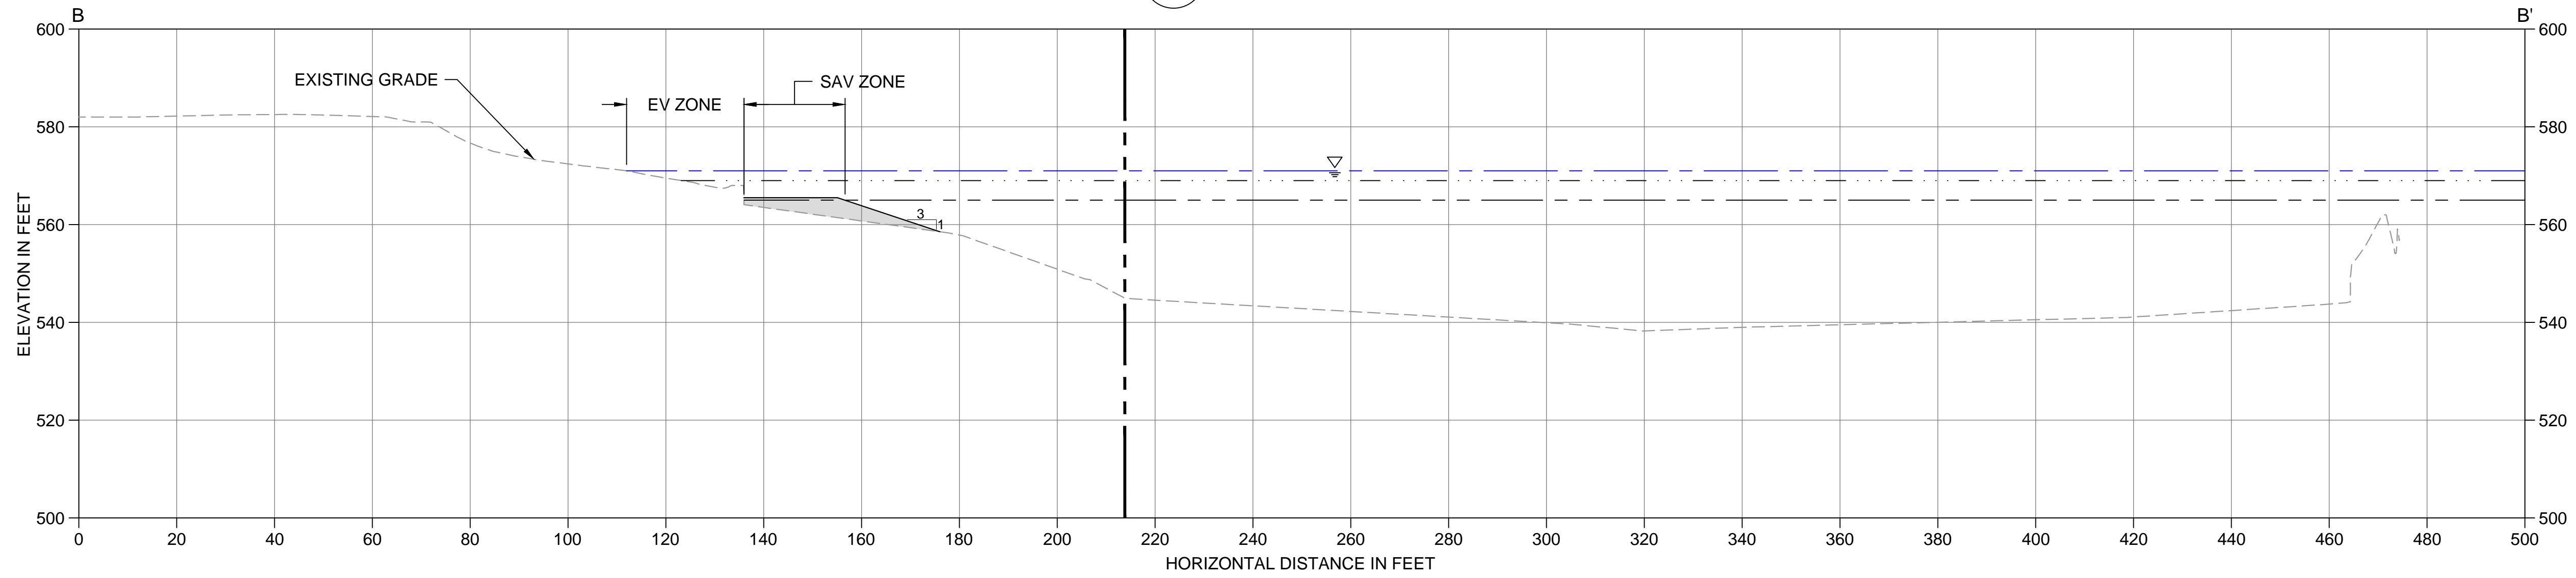LEGEND:

- EXISTING MUDLINE
- AVERAGE WSEL (571')
- FINISHED SUBGRADE
- EV ZONE LOWER ELEVATION LIMIT (569')
- SAV ZONE LOWER ELEVATION LIMIT (565')
- NAVIGATION CHANNEL BOUNDARY
- HABITAT SUBGRADE MATERIAL

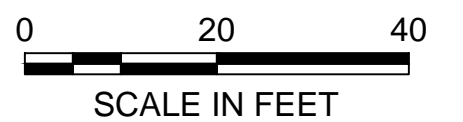

ONE INCH  
AT FULL SIZE, IF NOT ONE  
INCH SCALE ACCORDINGLY

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**BUFFALO RIVER AOC CAPPING AND HABITAT  
RESTORATION**


**CROSS-SECTIONS - KATHERINE  
STREET PENINSULA**

**C-08**


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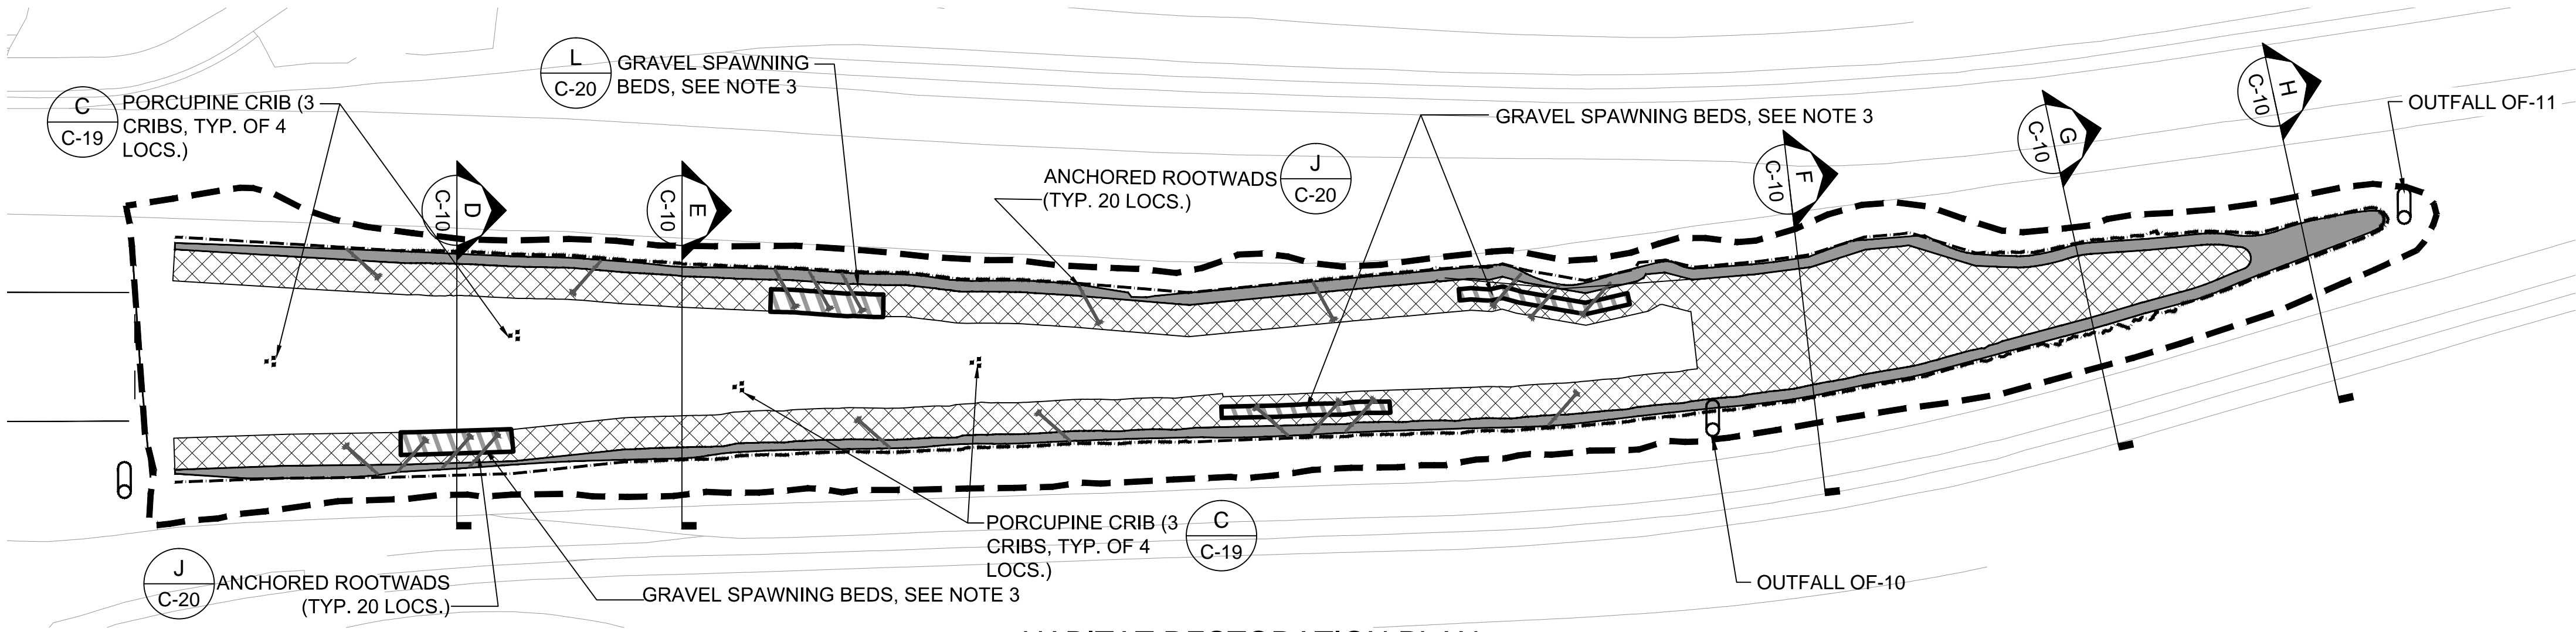
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CAPPING PLAN



FILL GRADING PLAN

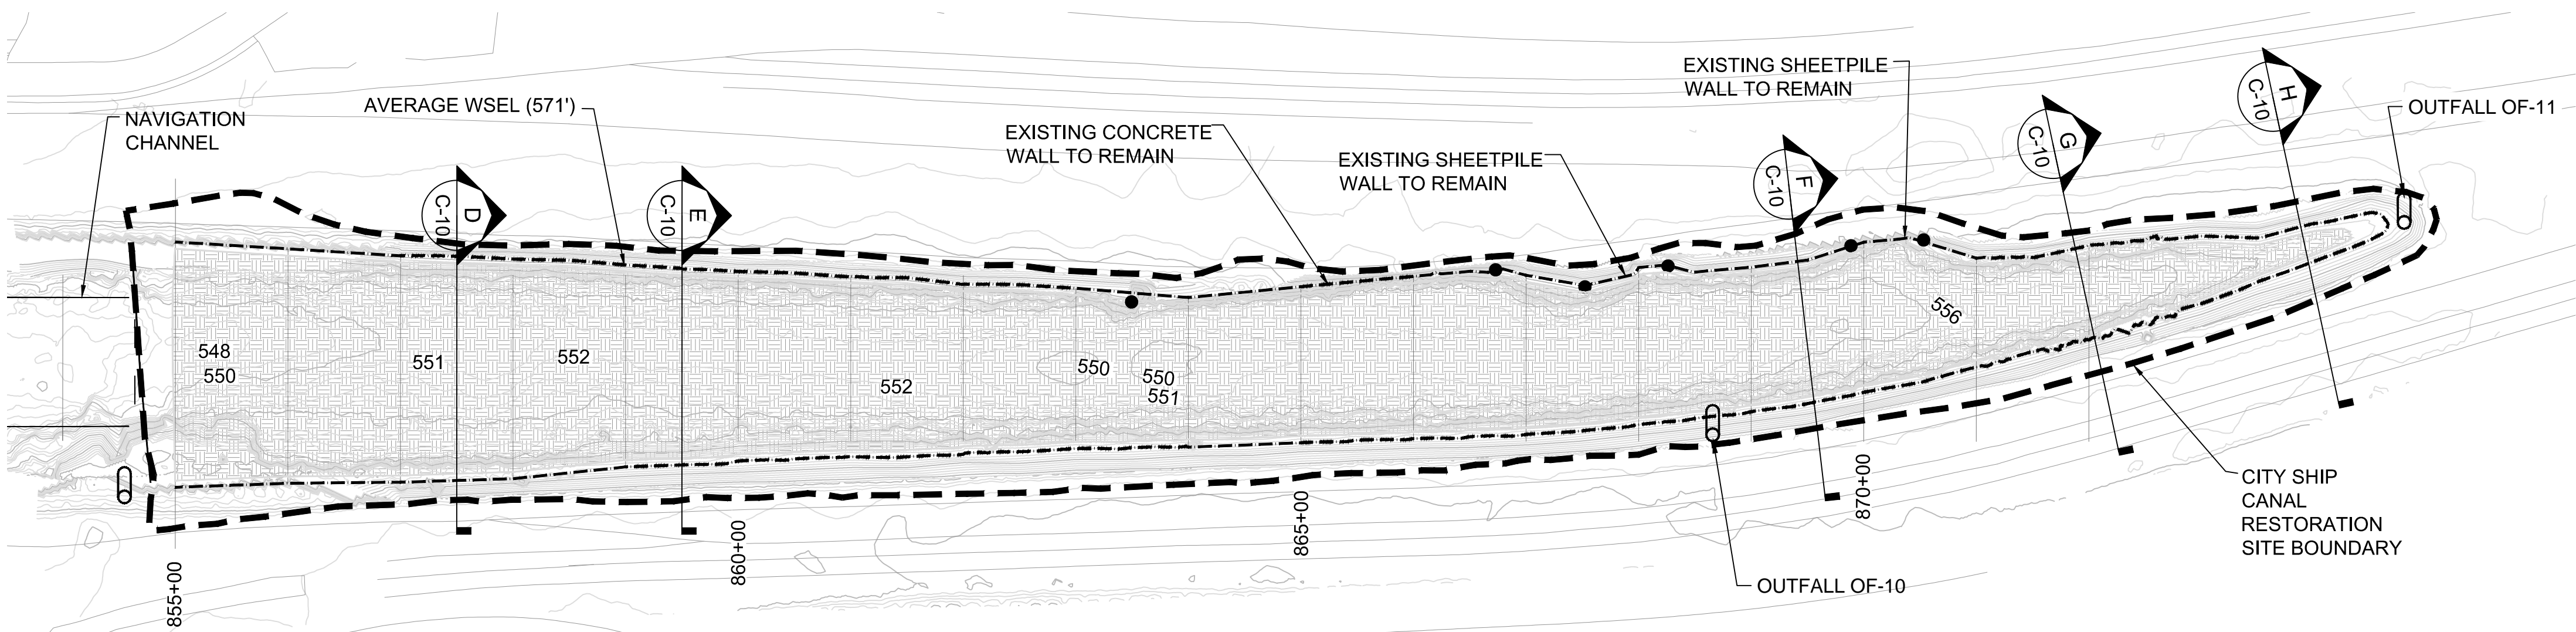

HABITAT RESTORATION PLAN

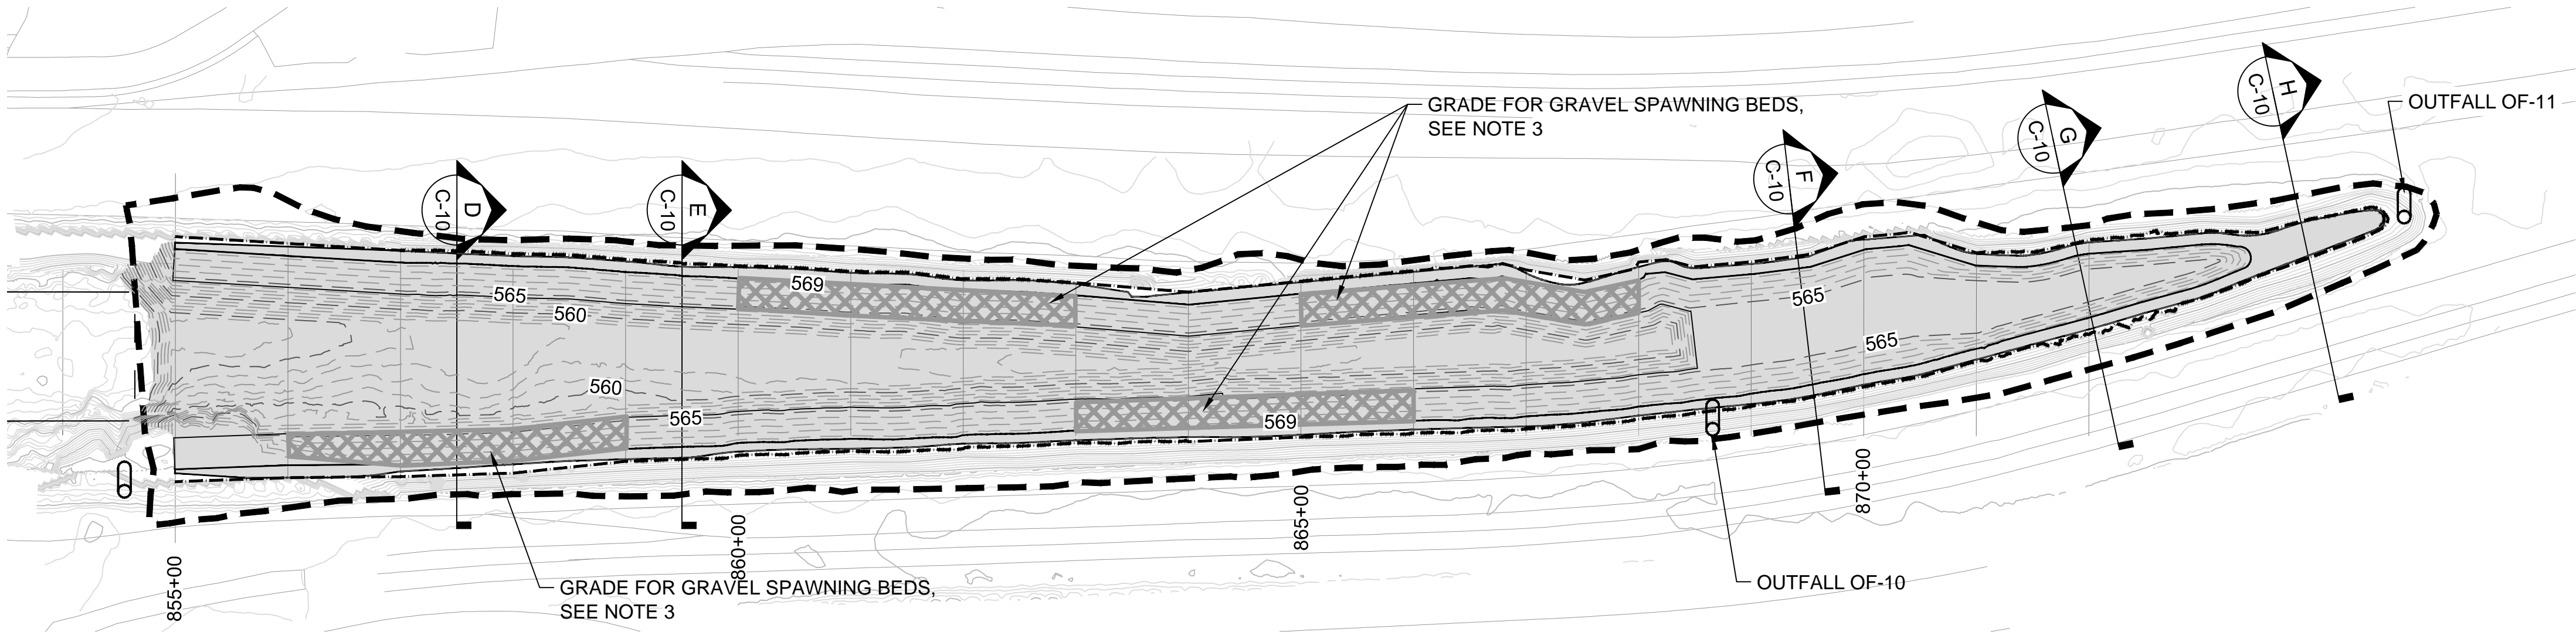
**LEGEND**

- RESTORATION AREA BOUNDARY
- AVERAGE WSEL (571')
- SUBMERGED AQUATIC VEGETATION (SAV) PLANTING AREA
- EMERGENT VEGETATION (EV) PLANTING AREA
- IN-WATER FILL
- CAP AREA
- APPROXIMATE GRAVEL SPAWNING BED GRADING AREA
- GRAVEL SPAWNING BED
- PORCUPINE CRIB
- ANCHORED ROOTWAD

- NOTES**
- IN-WATER FILL WILL BE PLACED OVER THE ENTIRE GRADING AREA SHOWN ON THIS DRAWING. THE FILL GRADING PLAN SHOWS THE FINAL IN-WATER FILL CONTOURS WITHIN THE CITY SHIP CANAL.
  - FOR DETAILS ON THE VARIOUS PLANTING TYPES (SAV & EV), SEE G-01. REFER TO SPECIFICATION FOR PLANT PREPARATION AND PLANTING EXECUTION. THE UPLAND LIMIT OF THE EV PLANTINGS IS AT ELEVATION 571'. FIELD VERIFY THE 571' ELEVATION.
  - LOCATION AND GRADING FOR GRAVEL SPAWNING BEDS MAY VARY WITHIN THE LIMITS SHOWN AS APPROVED BY THE OWNER'S REPRESENTATIVE.
    - PROVIDE A TOTAL COVERAGE AREA NO LESS THAN 7,000 SQUARE FEET DIVIDED BETWEEN FOUR (4) ISOLATED AREAS RANGING FROM 2,500 TO 1,000 SQUARE FEET EACH.
  - EXISTING OUTFALLS TO REMAIN INTACT AND FUNCTIONAL. SEE C-19 FOR OUTFALL SCOUR PROTECTION TO BE INSTALLED.

OUTFALLS	
OUTFALL ID	RIPRAP WIDTH (INCHES)
OF-10	72
OF-11	72

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ONE INCH  
= 100 FEET  
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INCH SCALE ACCORDINGLY

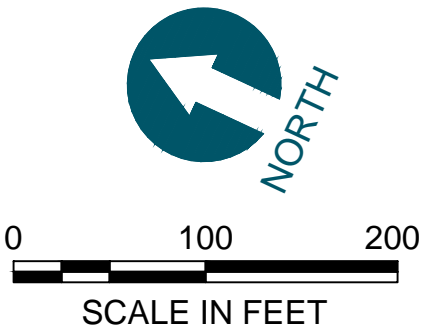

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APPROVED BY: P. DOODY  
DATE: MAY 2014

**BUFFALO RIVER AOC CAPPING AND HABITAT RESTORATION**


**HABITAT RESTORATION PLAN VIEW - CITY SHIP CANAL**

**C-09**


SHEET NO. 12 OF 23




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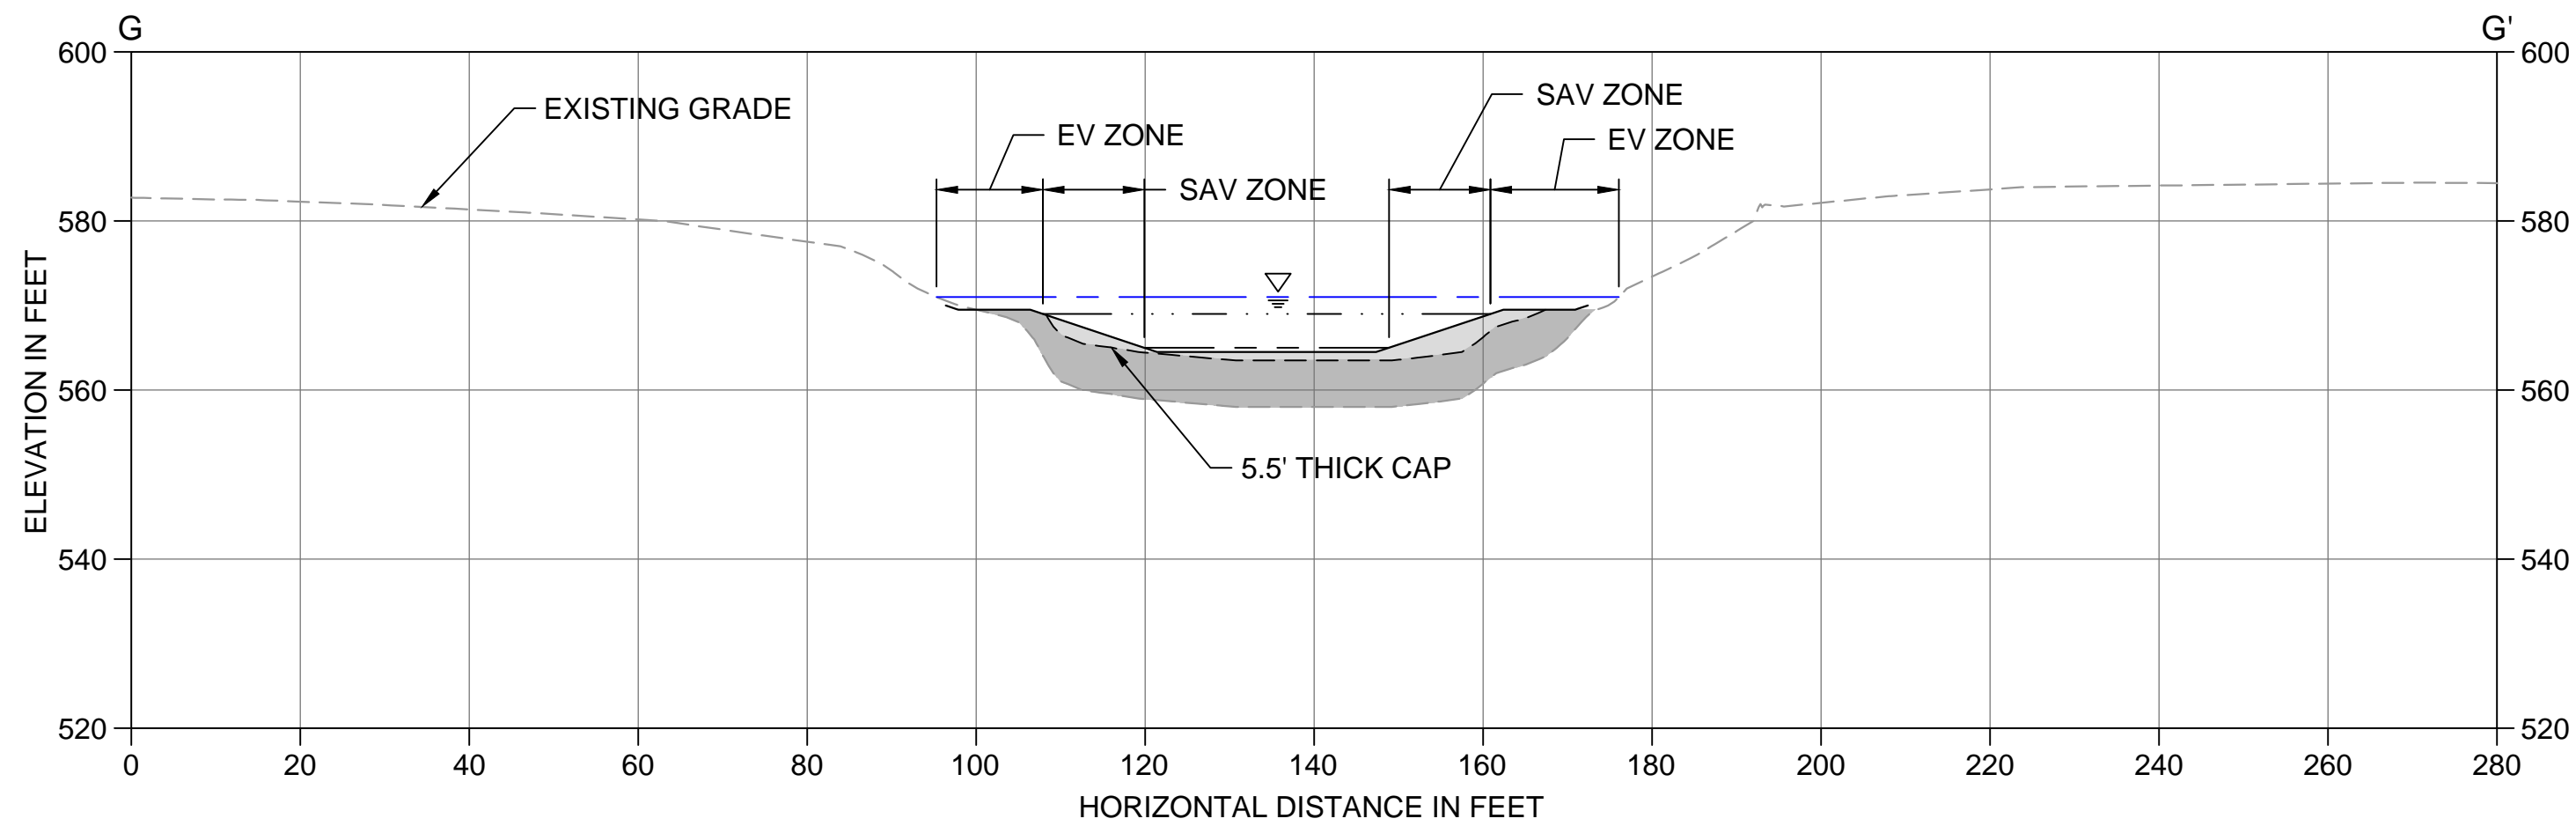
**D**  
SECTION D-D'  
SCALE: 1" = 20'

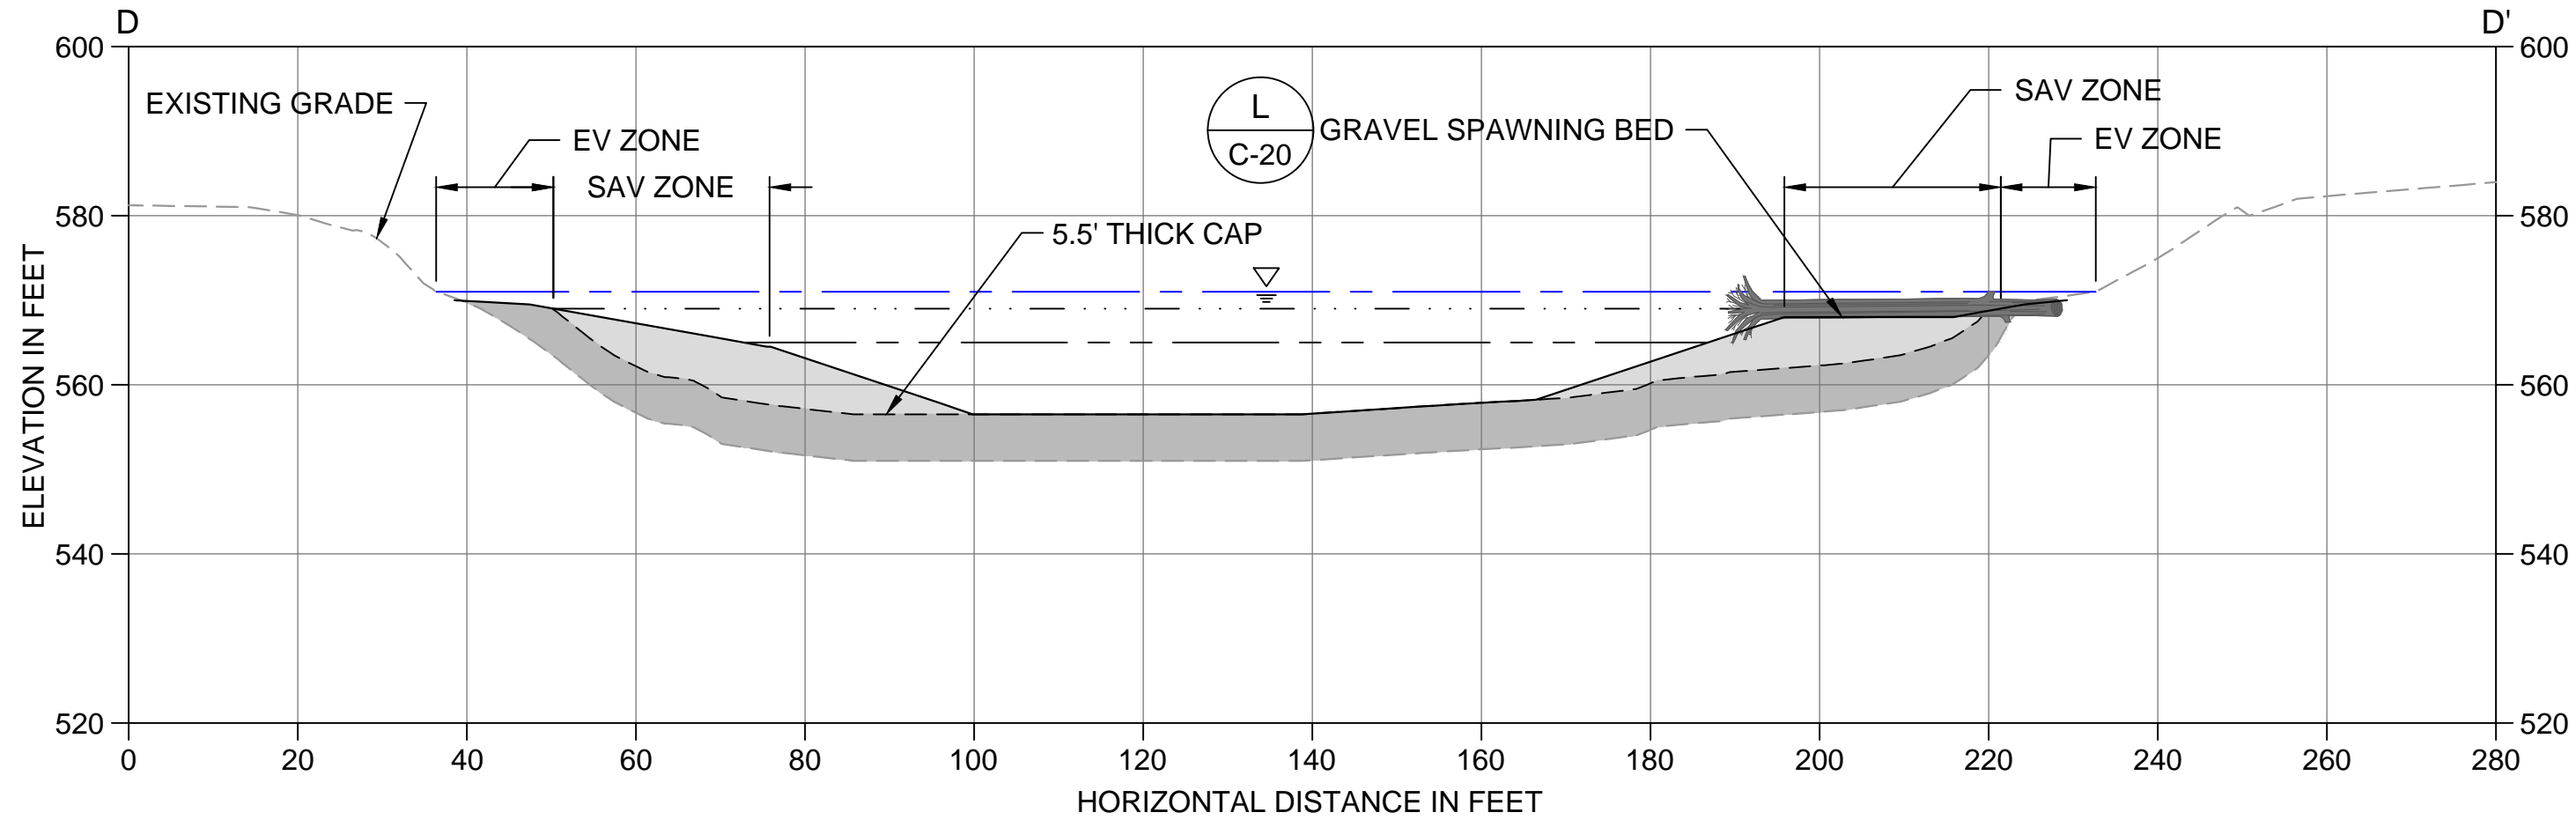


**E**  
SECTION E-E'  
SCALE: 1" = 20'

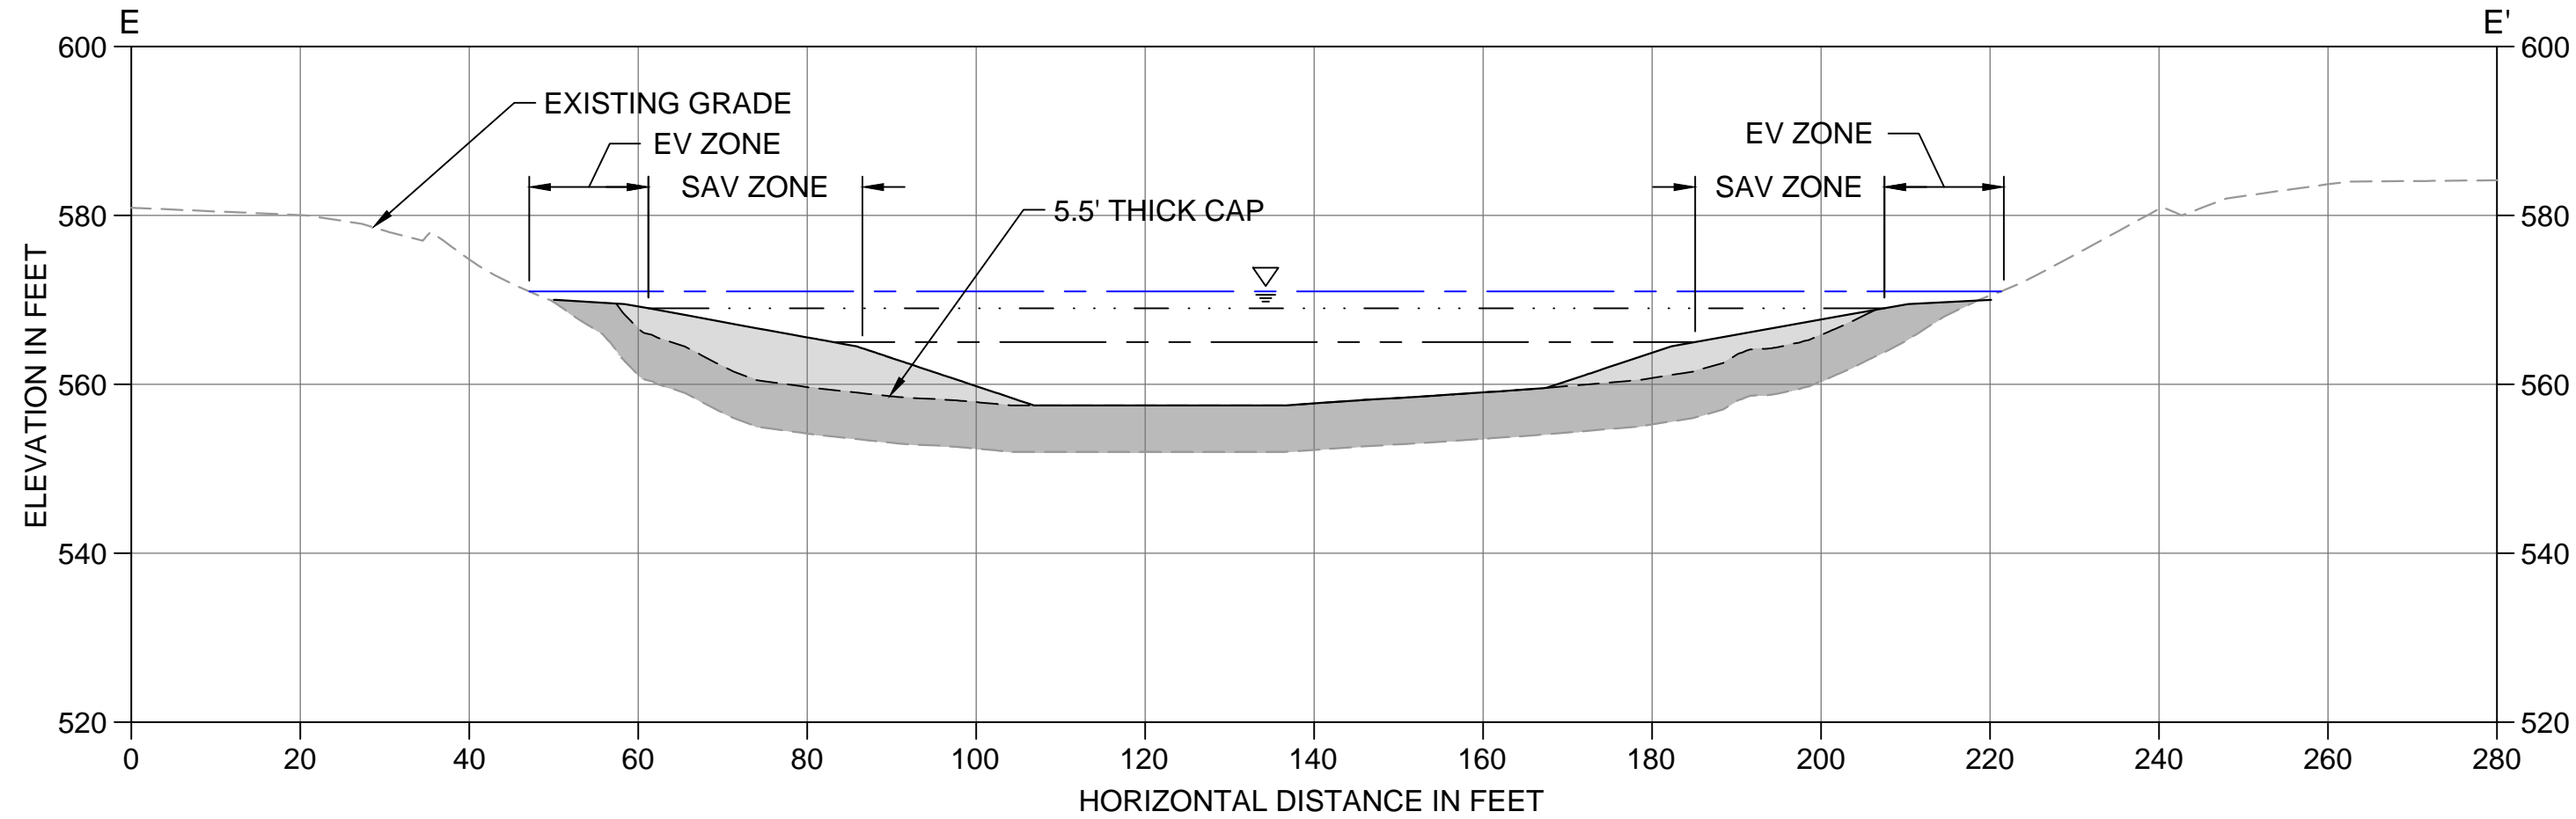

**F**  
SECTION F-F'  
SCALE: 1" = 20'

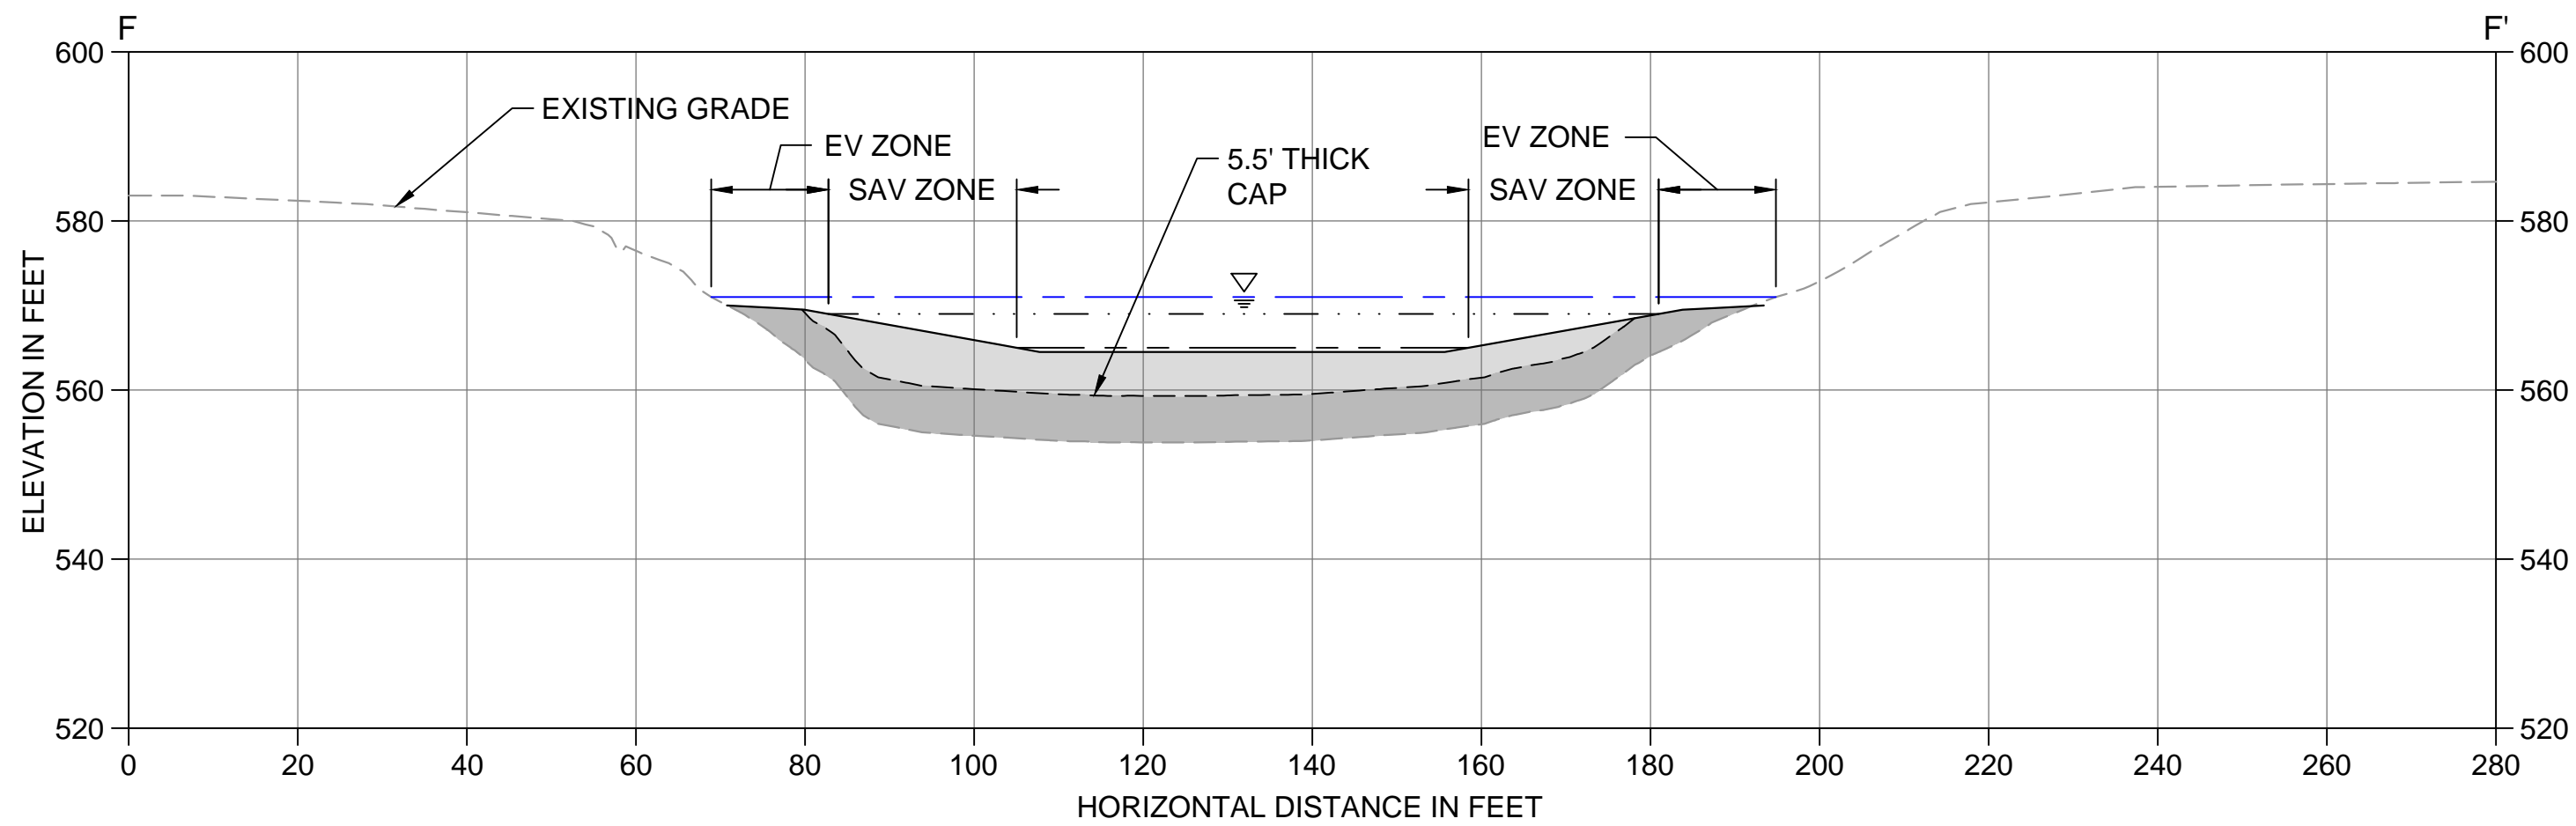


**G**  
SECTION G-G'  
SCALE: 1" = 20'

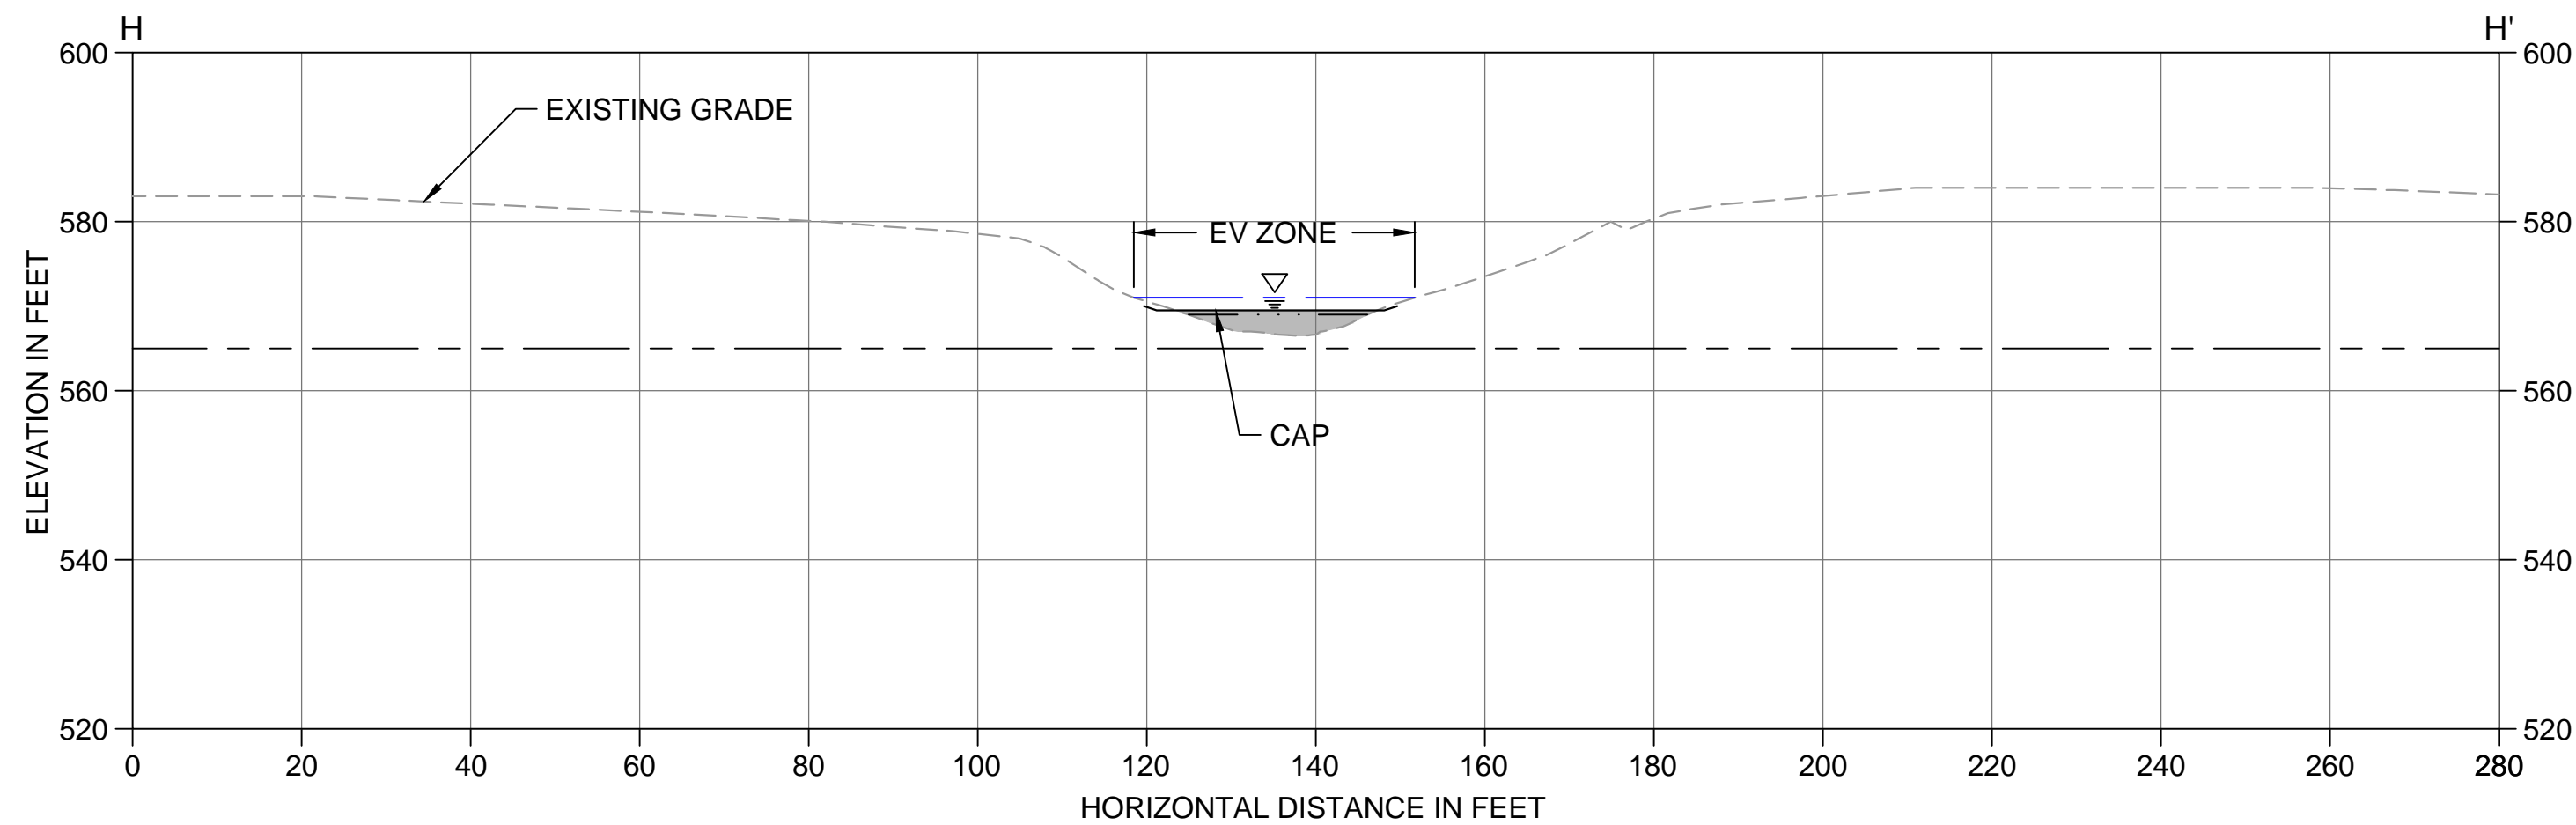

**H**  
SECTION H-H'  
SCALE: 1" = 20'

- LEGEND:
- EXISTING MUDLINE
  - AVERAGE WSEL (571')
  - FINISHED SUBGRADE
  - EV ZONE LOWER ELEVATION LIMIT (569')
  - SAV ZONE LOWER ELEVATION LIMIT (565')
  - CAP SURFACE
  - LIMIT OF CAP PLACEMENT
  - ADDITIONAL IN-WATER FILL FOR HABITAT RESTORATION

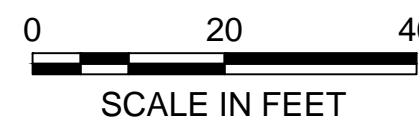

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DRAWN BY: C. HEWETT  
CHECKED BY: S. BAGNULL  
APPROVED BY: P. DOODY  
DATE: MAY 2014

**BUFFALO RIVER AOC CAPPING AND HABITAT  
RESTORATION**

**CROSS-SECTIONS - CITY SHIP CANAL**

**C-10**

SHEET NO. 13 OF 23







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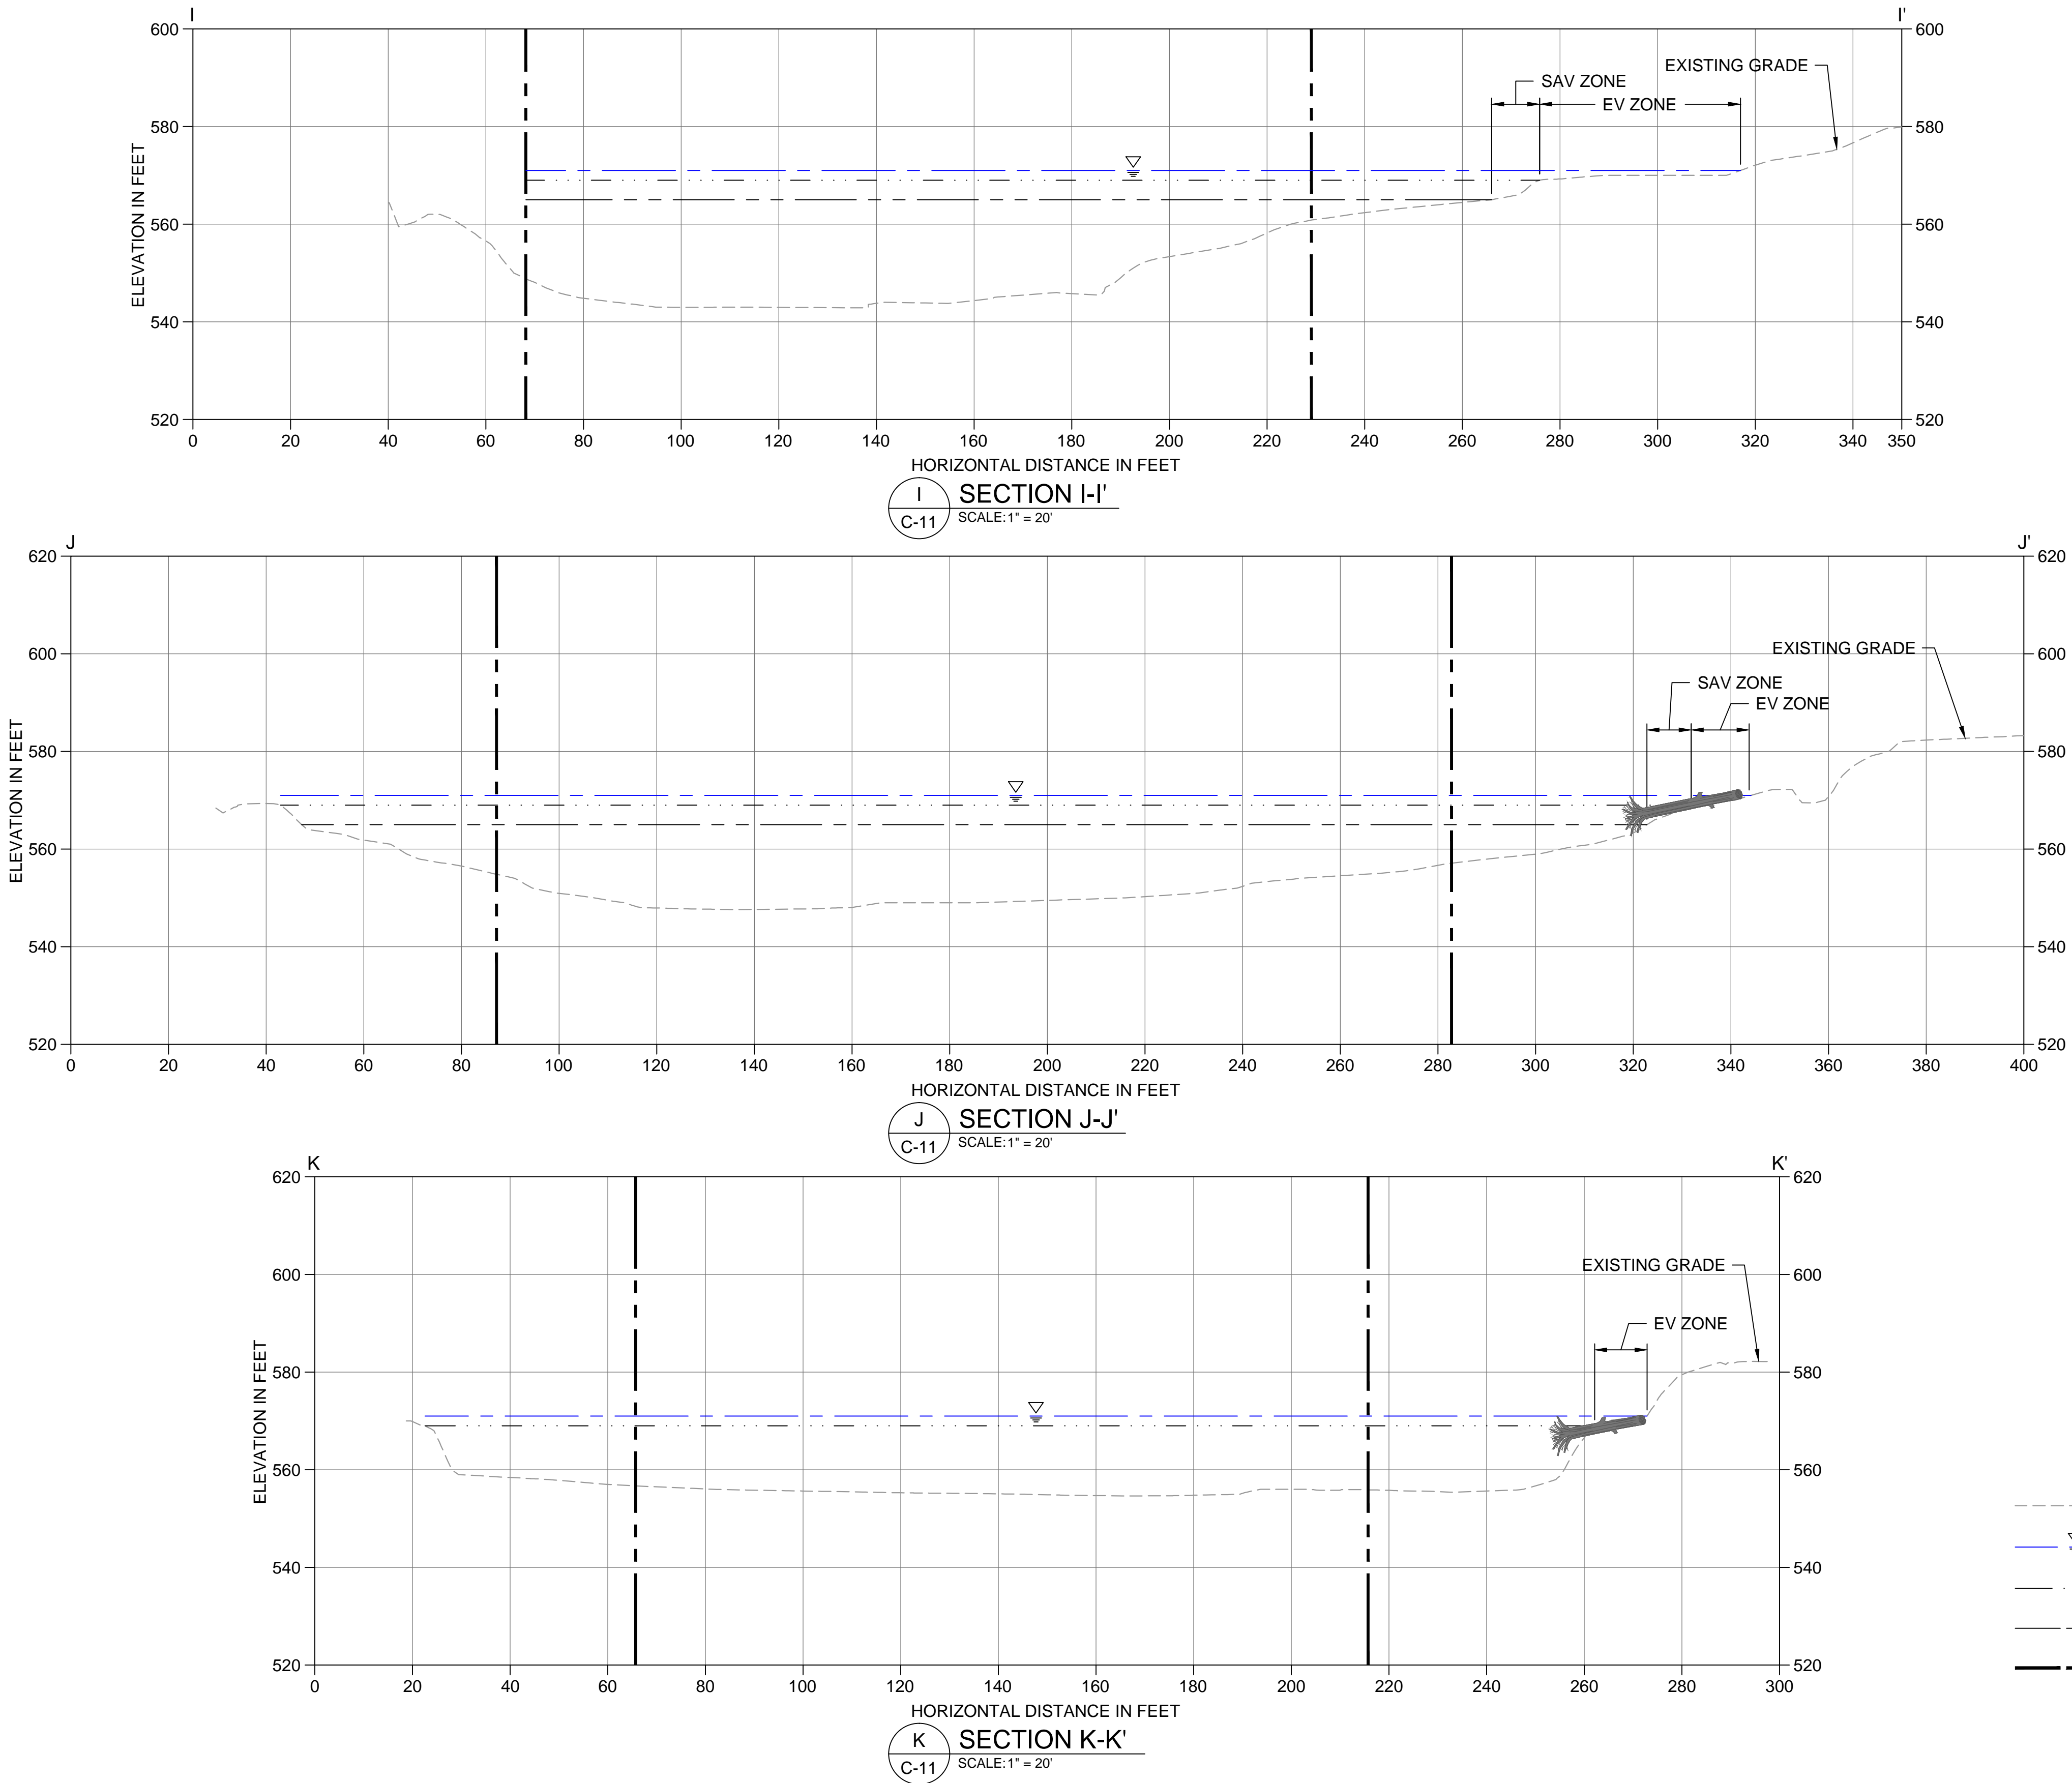
DESIGNED BY: J. GAFFNEY  
DRAWN BY: C. HEWETT  
CHECKED BY: M. REEMTS  
APPROVED BY: P. DOODY  
DATE: MAY 2014

BUFFALO RIVER AOC CAPPING AND HABITAT  
RESTORATION

CROSS-SECTIONS - RIVERBEND  
(EAST)

C-12

SHEET NO. 15 OF 23





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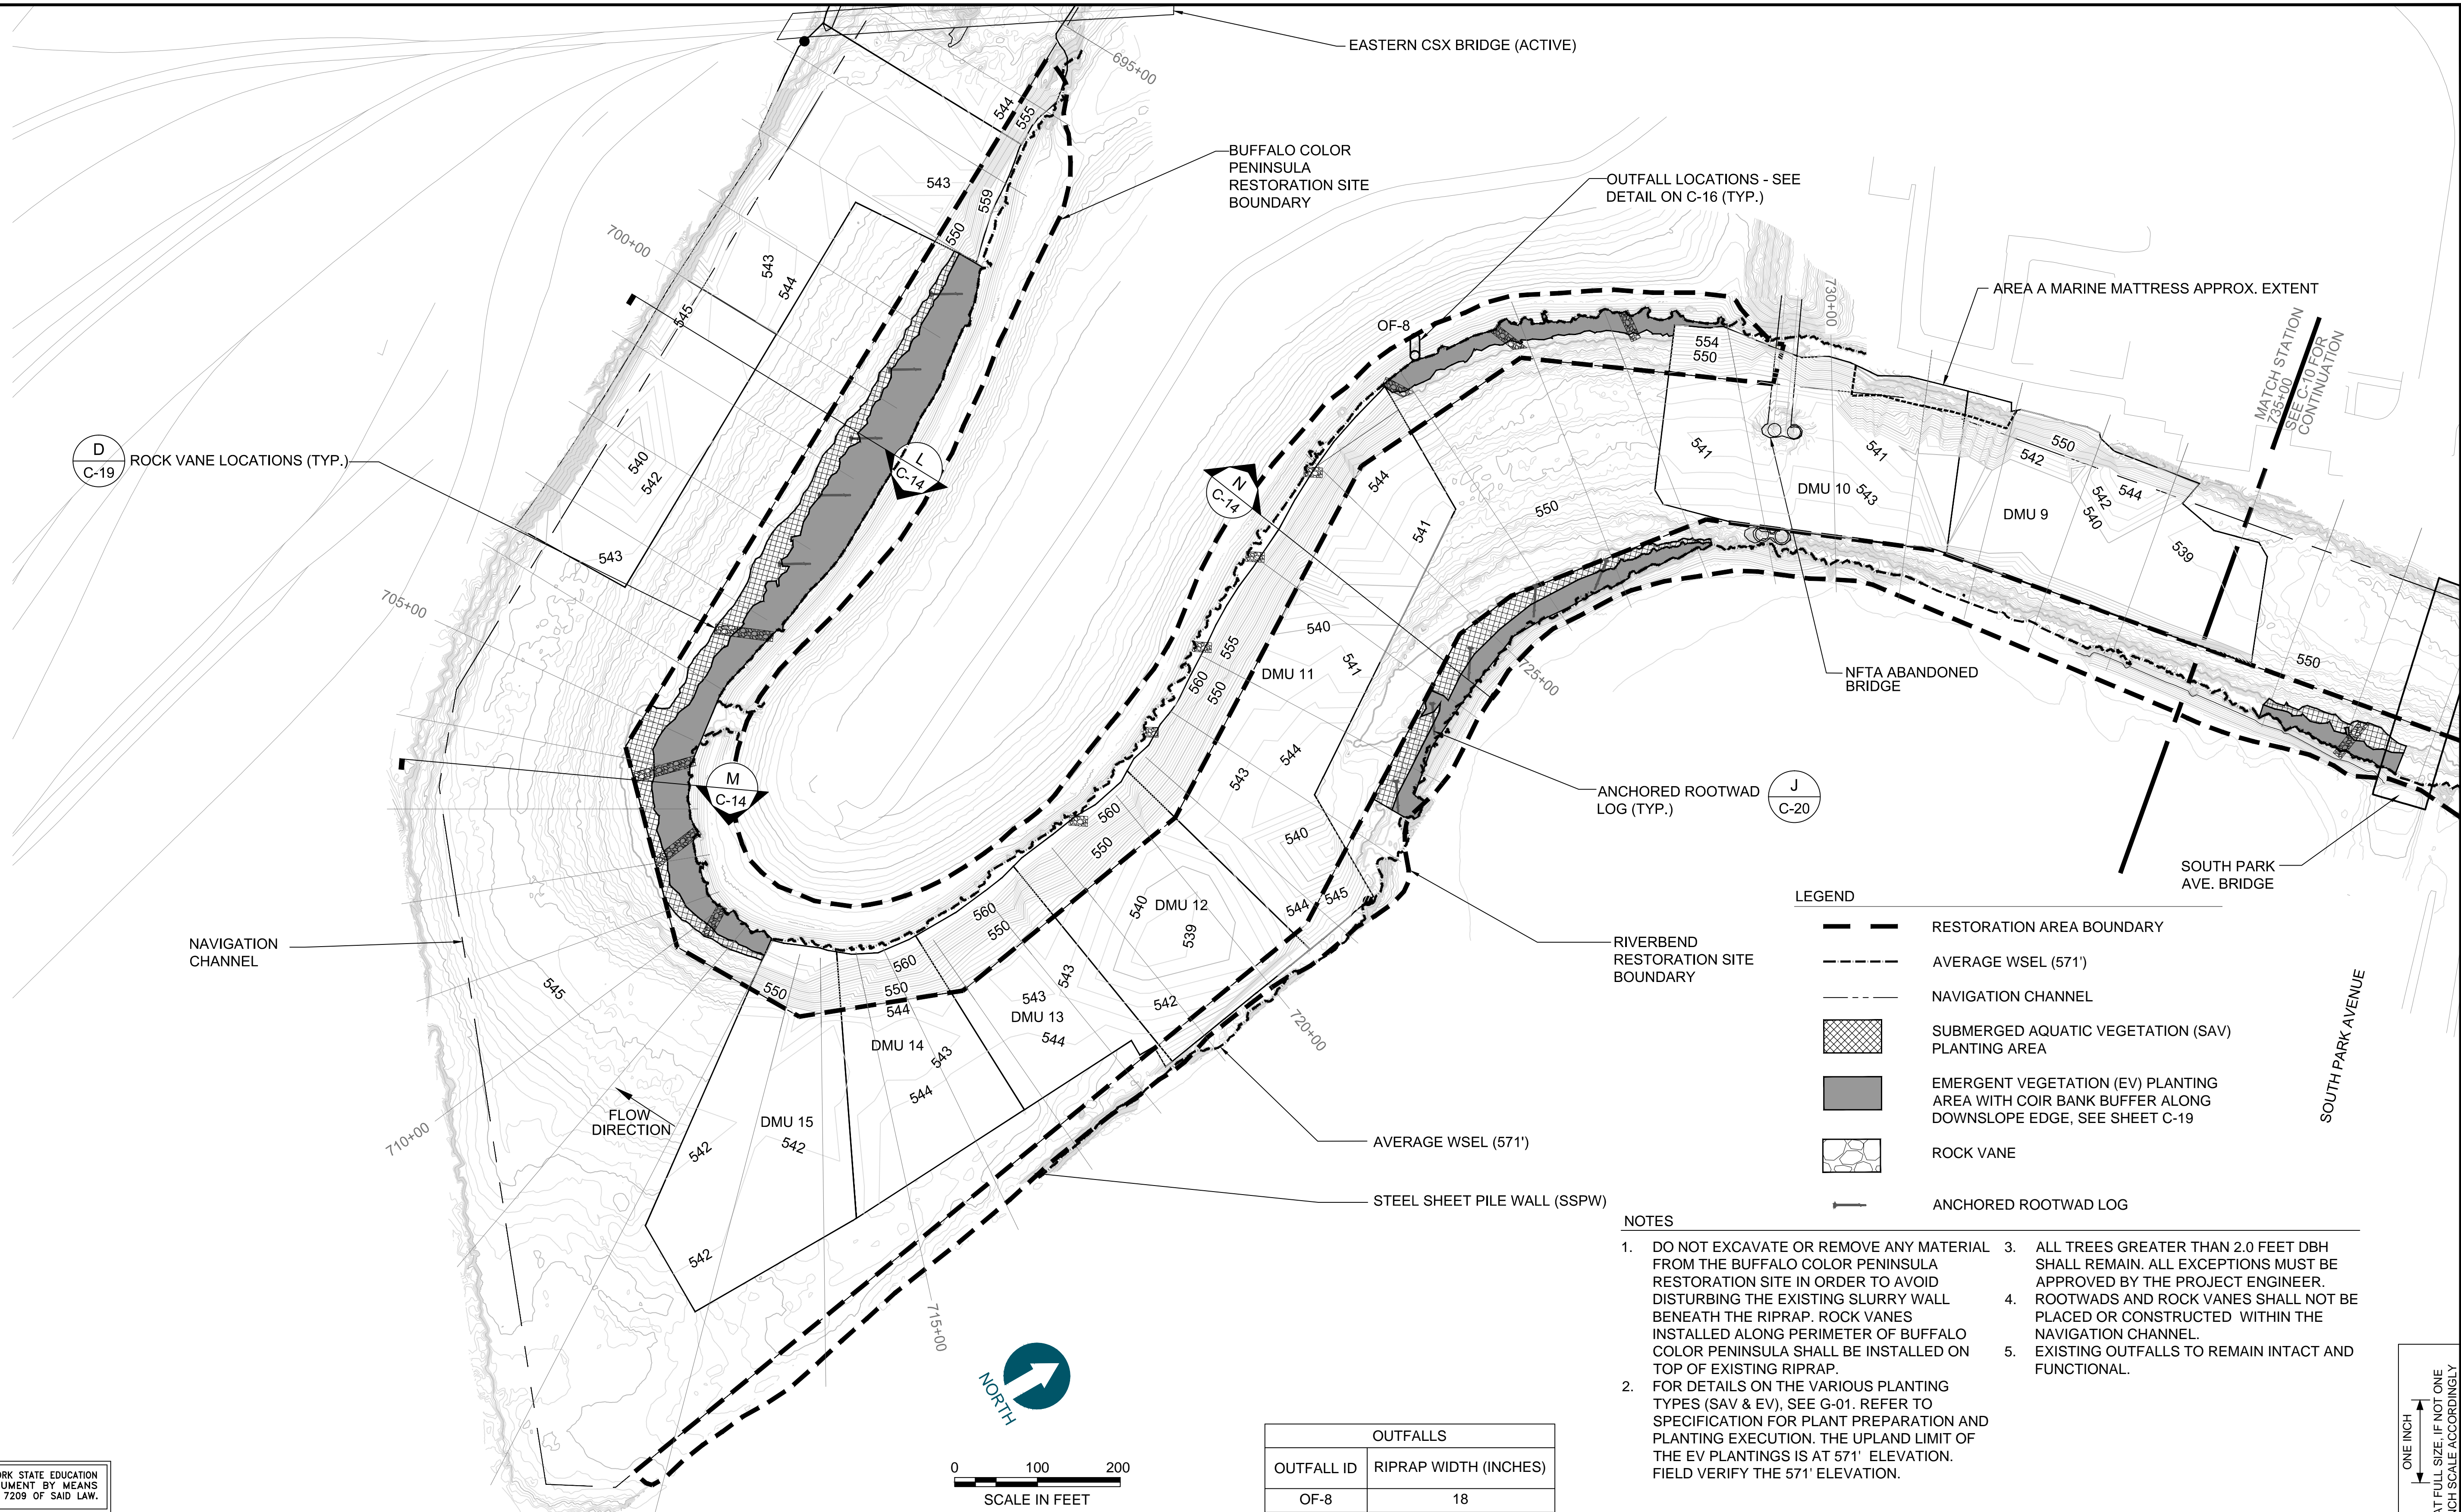
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DRAWN BY: C. HEWETT  
CHECKED BY: M. REEMTS  
APPROVED BY: P. DOODY  
DATE: MAY 2014

**BUFFALO RIVER AOC CAPPING AND HABITAT  
RESTORATION**

**HABITAT RESTORATION PLAN VIEW -  
BUFFALO COLOR PENINSULA AND  
RIVERBEND (WEST)**

**C-13**

SHEET NO. **16** OF **23**





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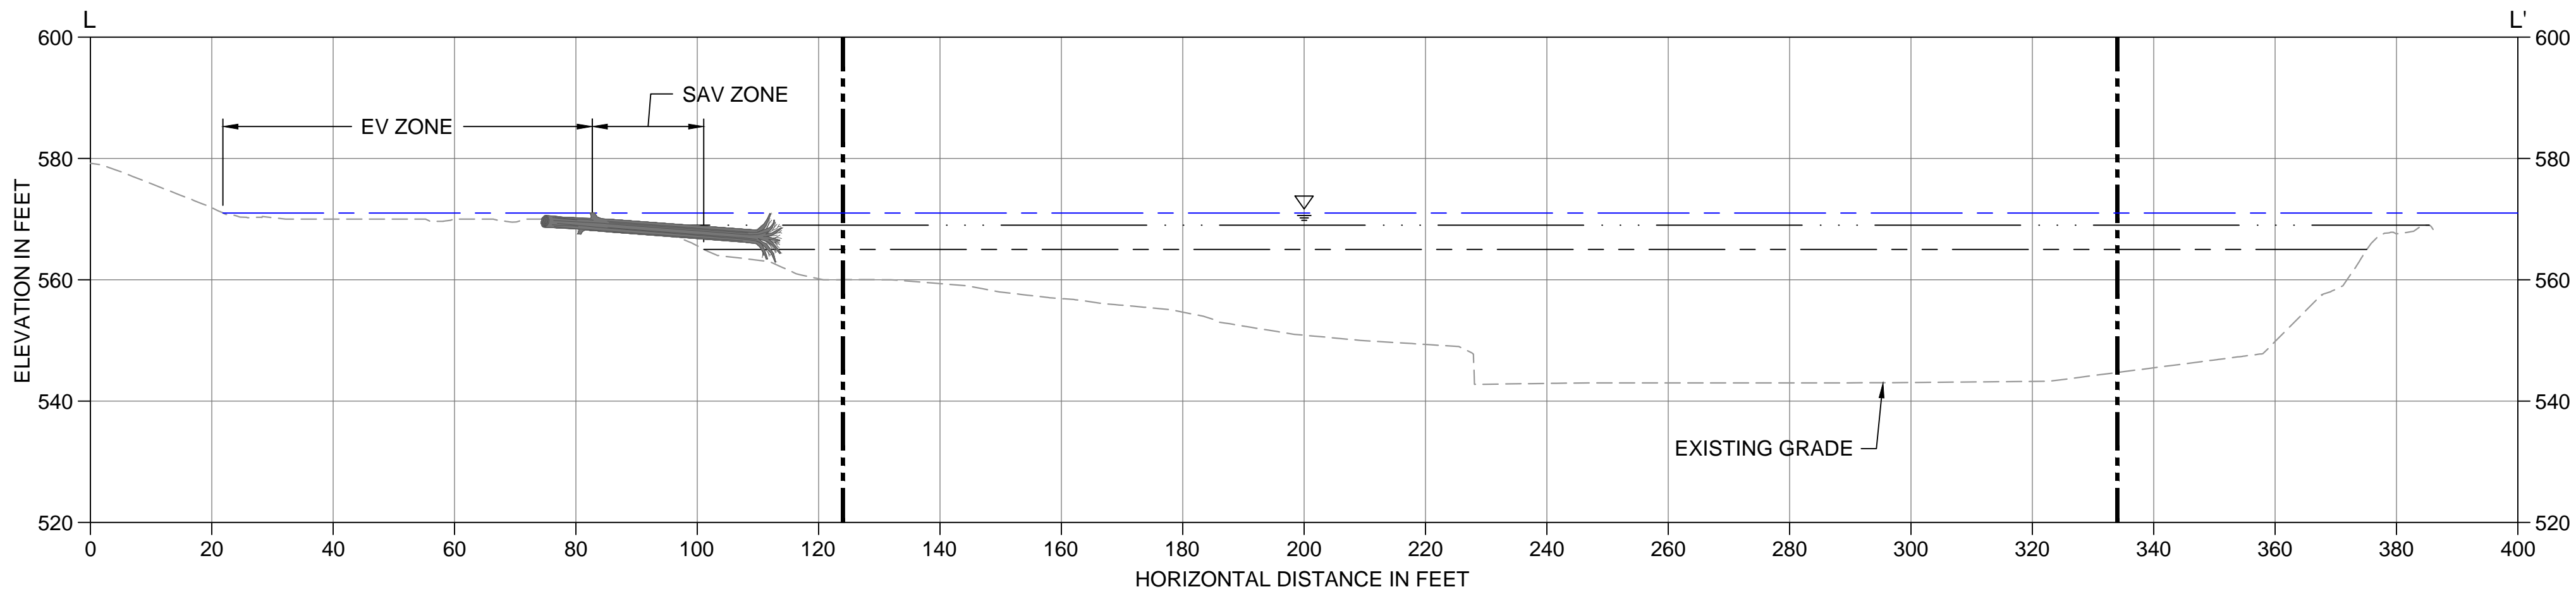
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DRAWN BY: C. HEWETT  
CHECKED BY: M. REEMTS  
APPROVED BY: P. DOODY  
DATE: MAY 2014

**BUFFALO RIVER AOC CAPPING AND HABITAT  
RESTORATION**


**CROSS-SECTIONS - BUFFALO COLOR  
PENINSULA AND RIVERBEND (WEST)**

**C-14**


SHEET NO. 17 OF 23



**SECTION L-L'**  
SCALE: 1" = 20'

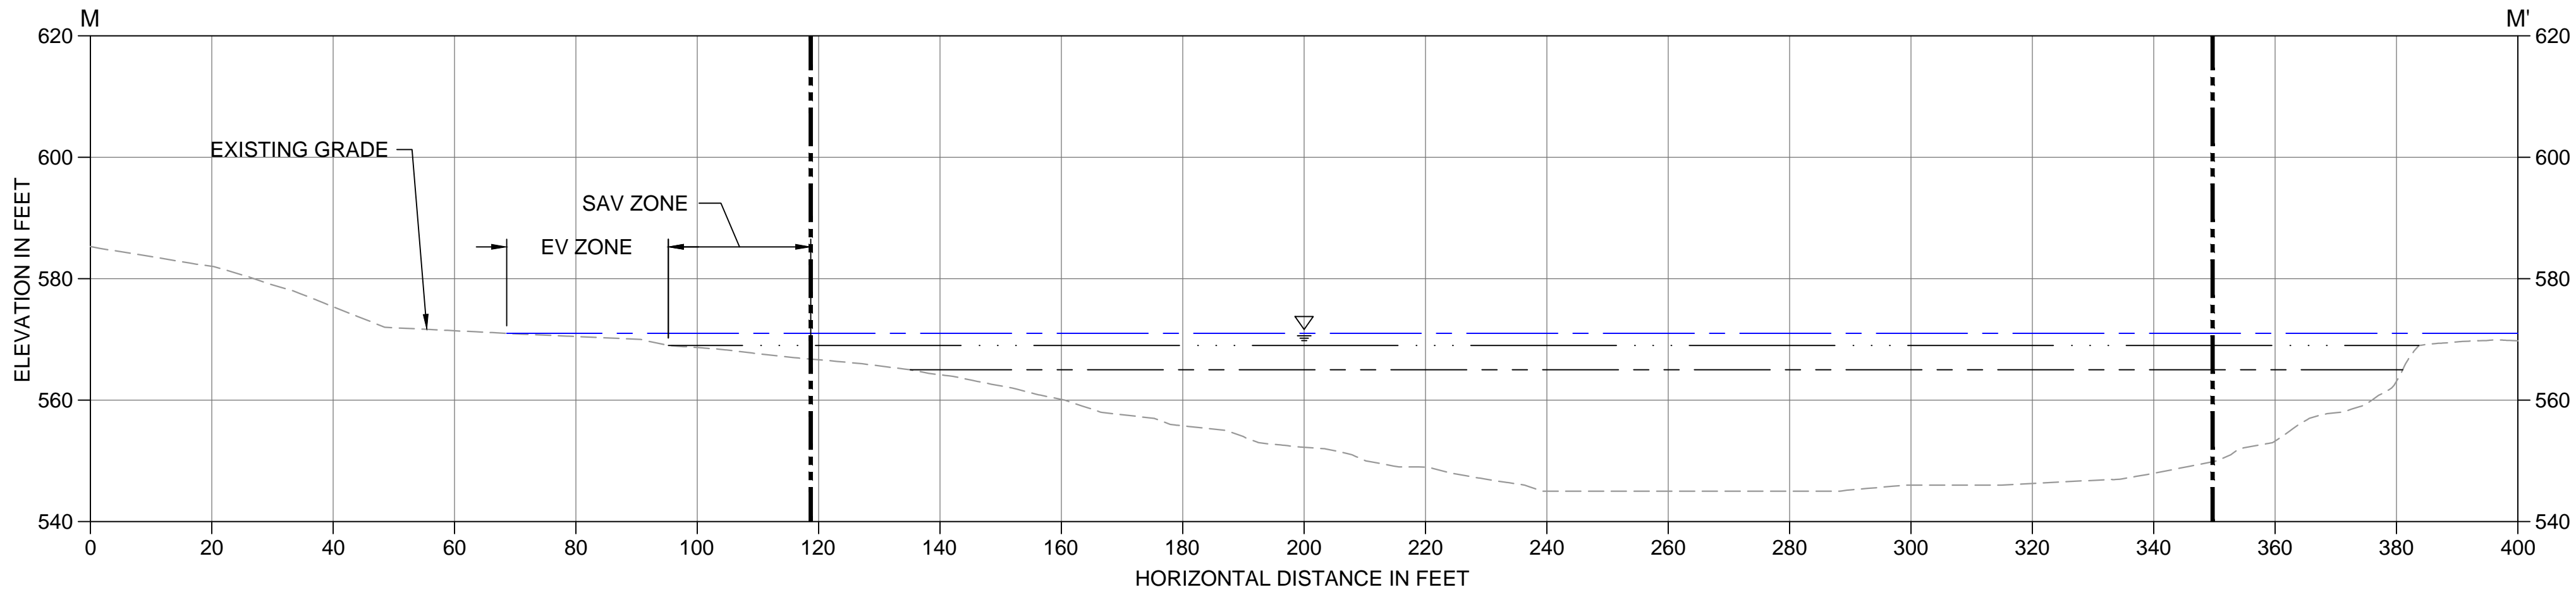

**SECTION M-M'**  
SCALE: 1" = 20'

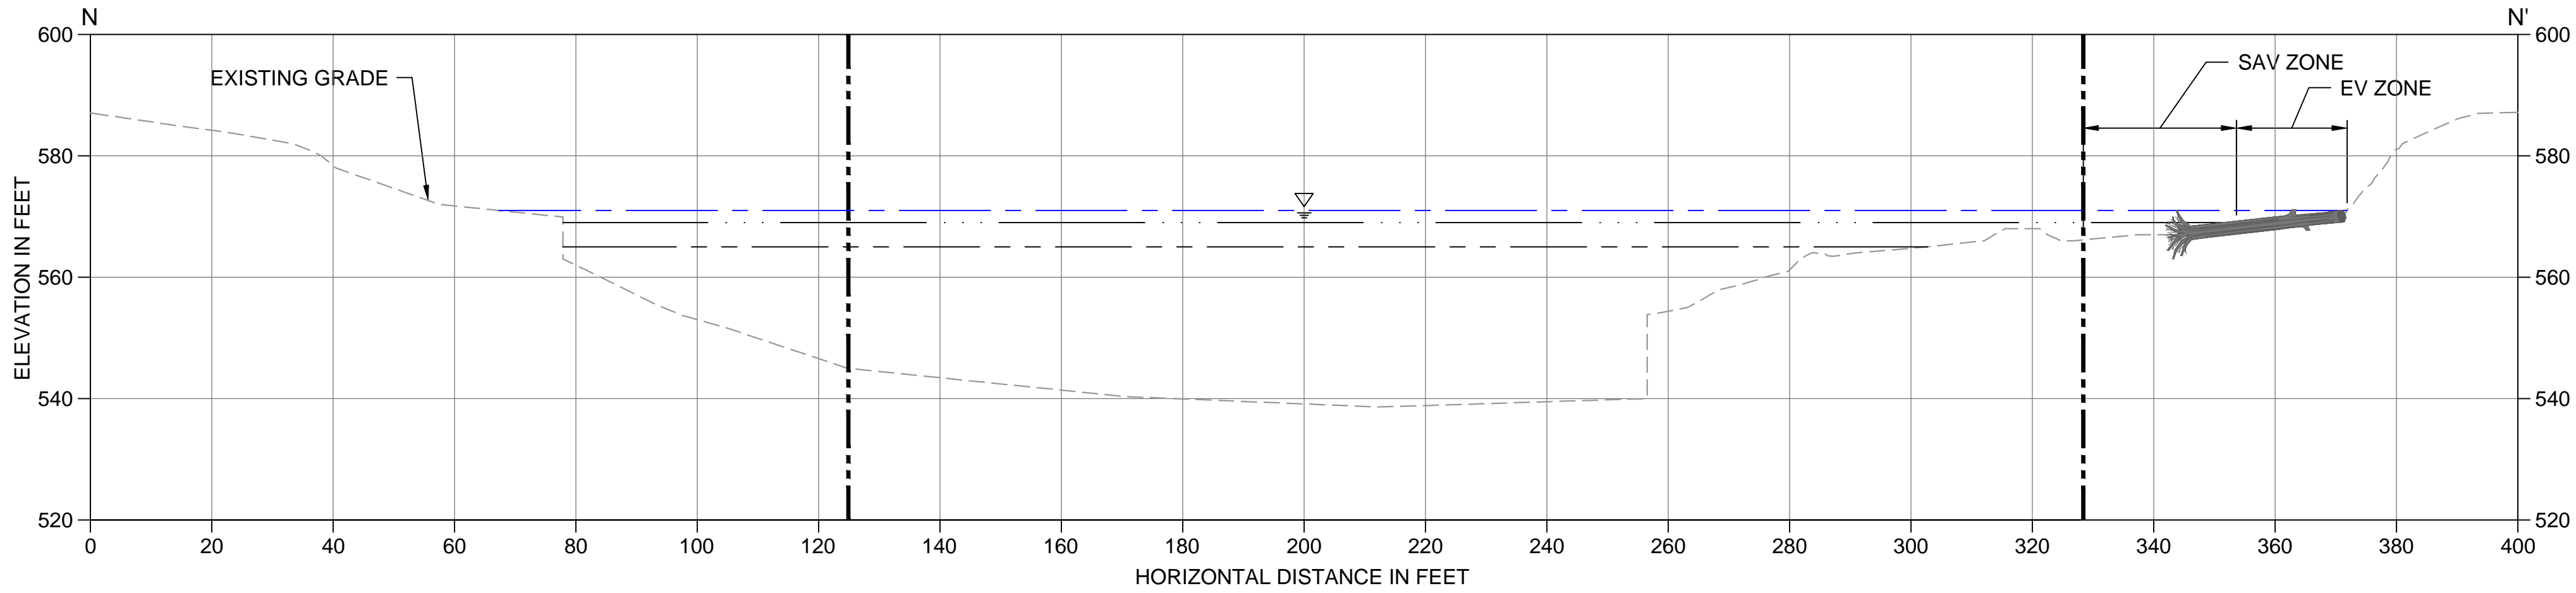

**SECTION N-N'**  
SCALE: 1" = 20'

- LEGEND:
- EXISTING MUDLINE
  - AVERAGE WSEL (571')
  - EV ZONE LOWER ELEVATION LIMIT (569')
  - SAV ZONE LOWER ELEVATION LIMIT (565')
  - NAVIGATION CHANNEL BOUNDARY



ONE INCH  
AT FULL SIZE, IF NOT ONE  
INCH SCALE ACCORDINGLY



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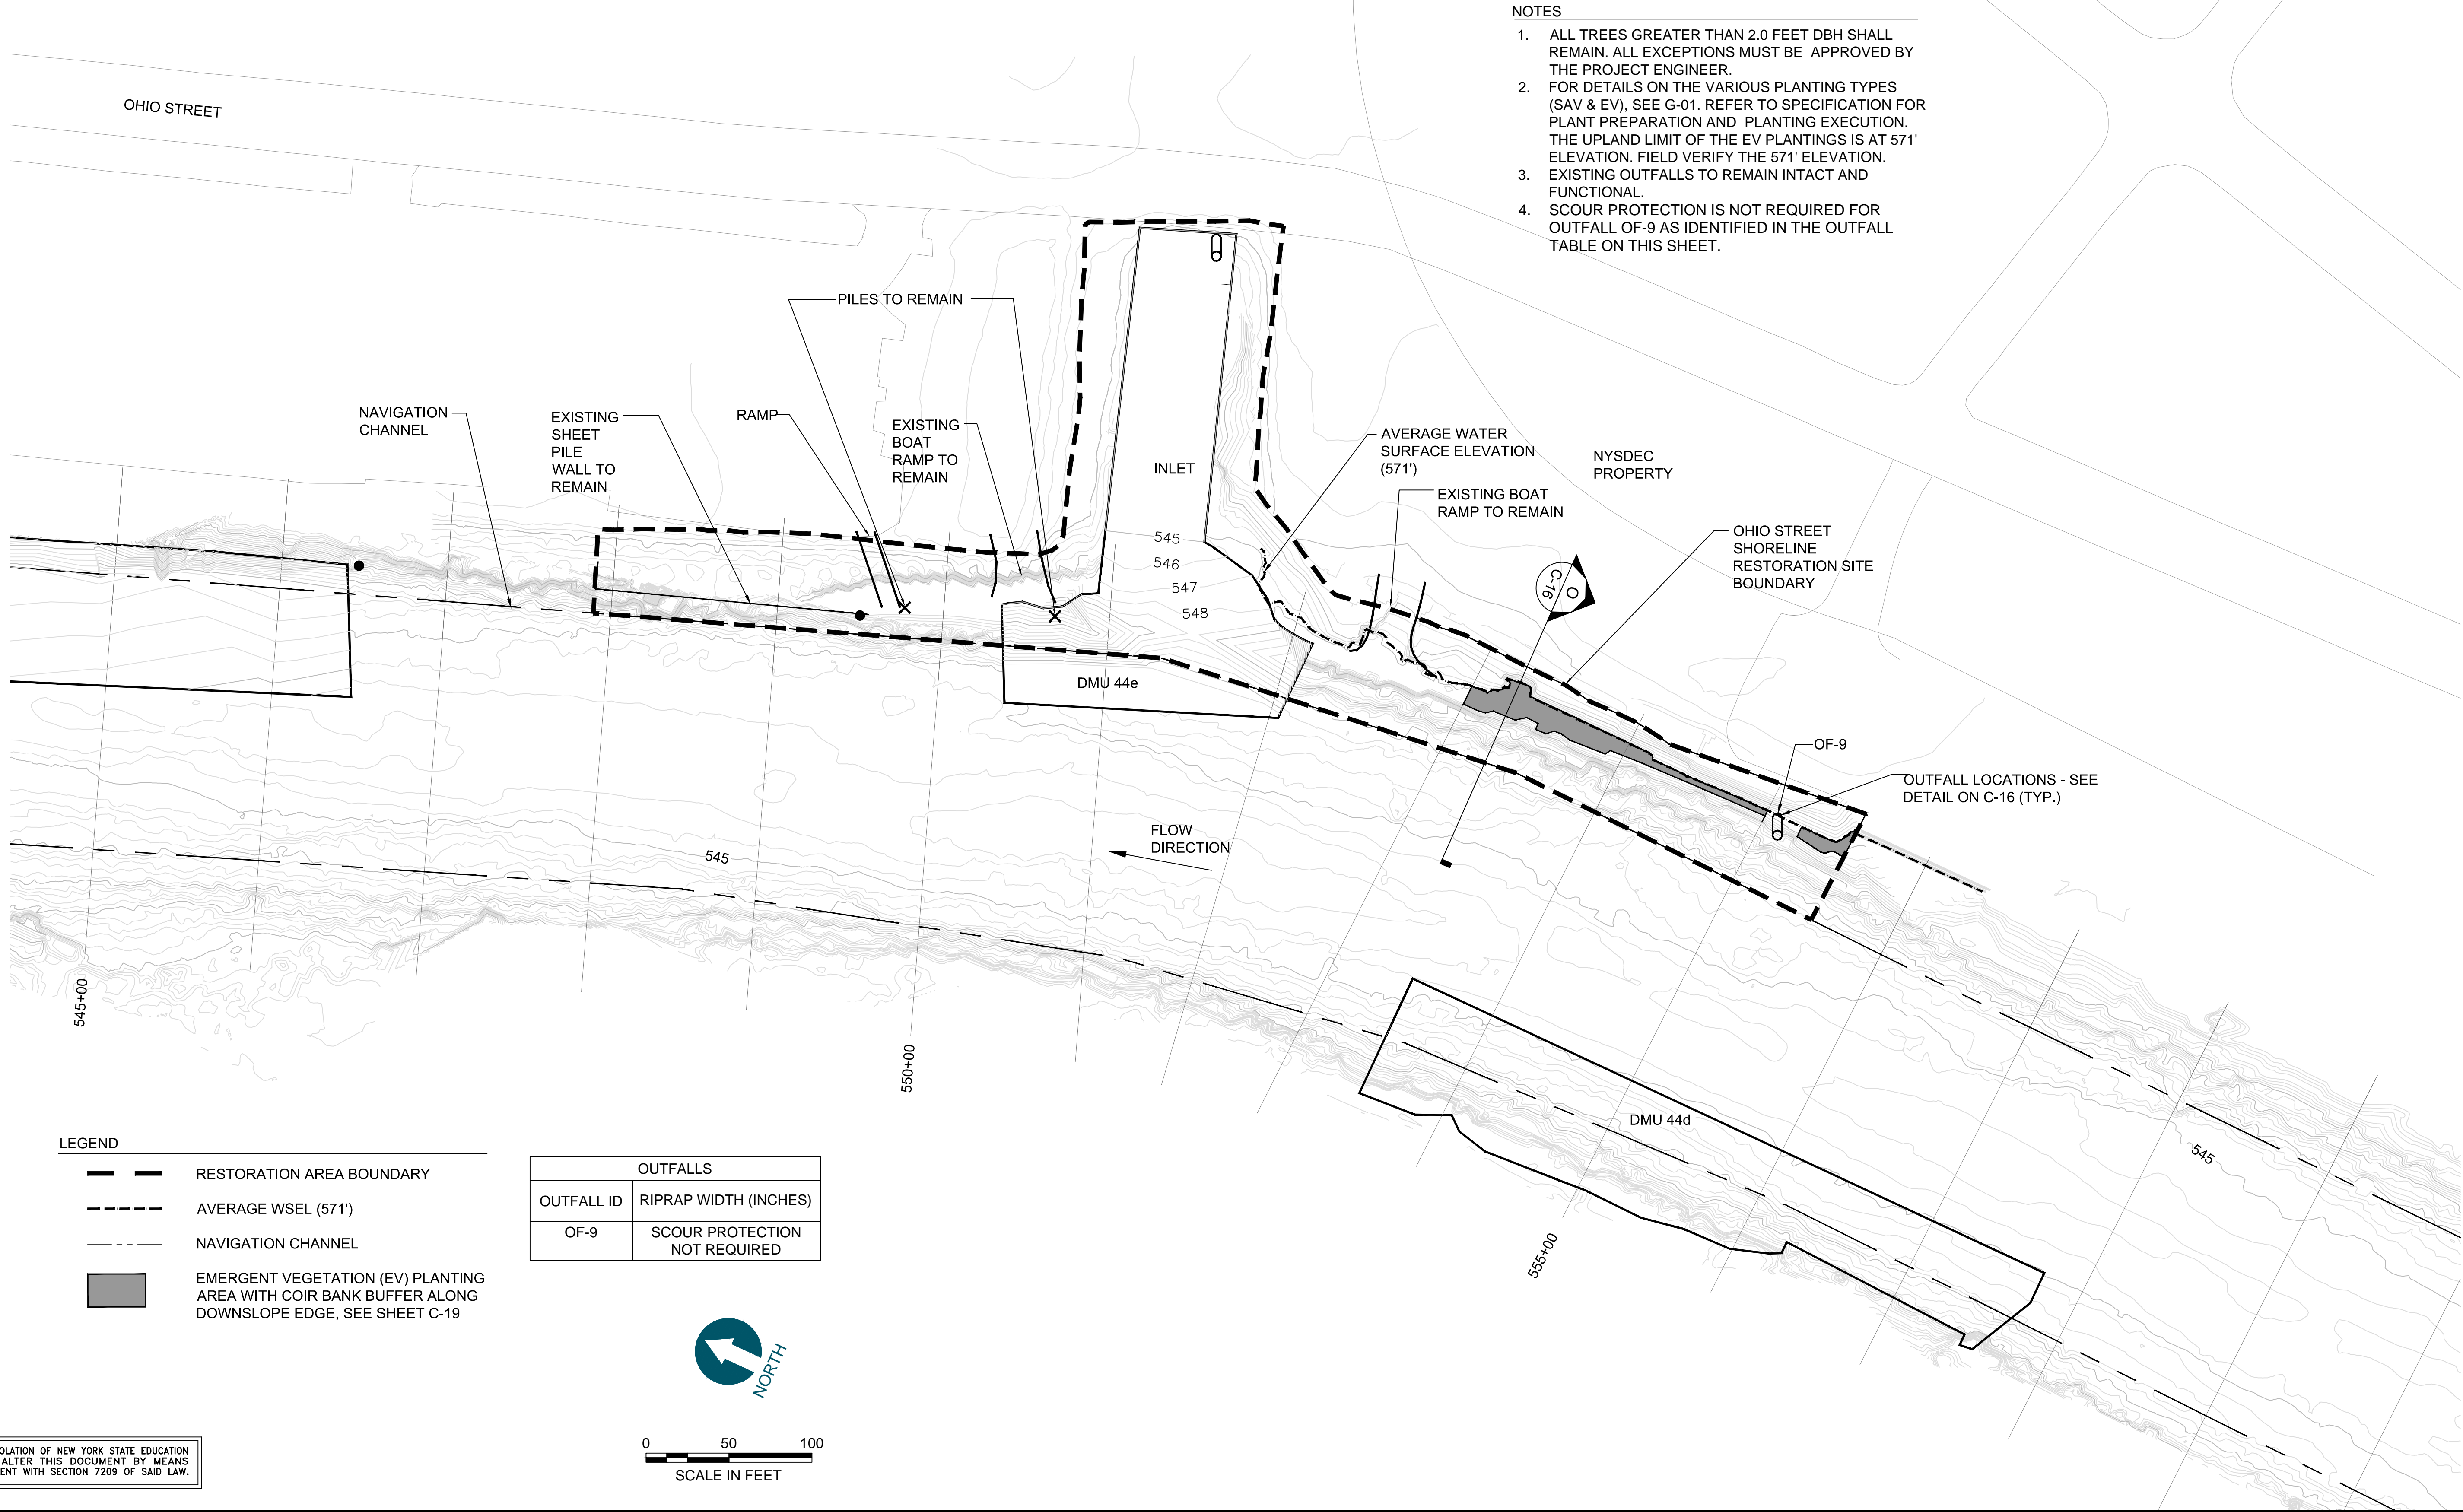
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DRAWN BY: C. HEWETT  
CHECKED BY: M. REEMTS  
APPROVED BY: P. DOODY  
DATE: MAY 2014

**BUFFALO RIVER AOC CAPPING AND HABITAT  
RESTORATION**

**HABITAT RESTORATION PLAN VIEW -  
OHIO STREET SHORELINE**

**C-15**  
SHEET NO. 18 OF 23



ONE INCH  
AT FULL SIZE, IF NOT ONE  
INCH SCALE ACCORDINGLY



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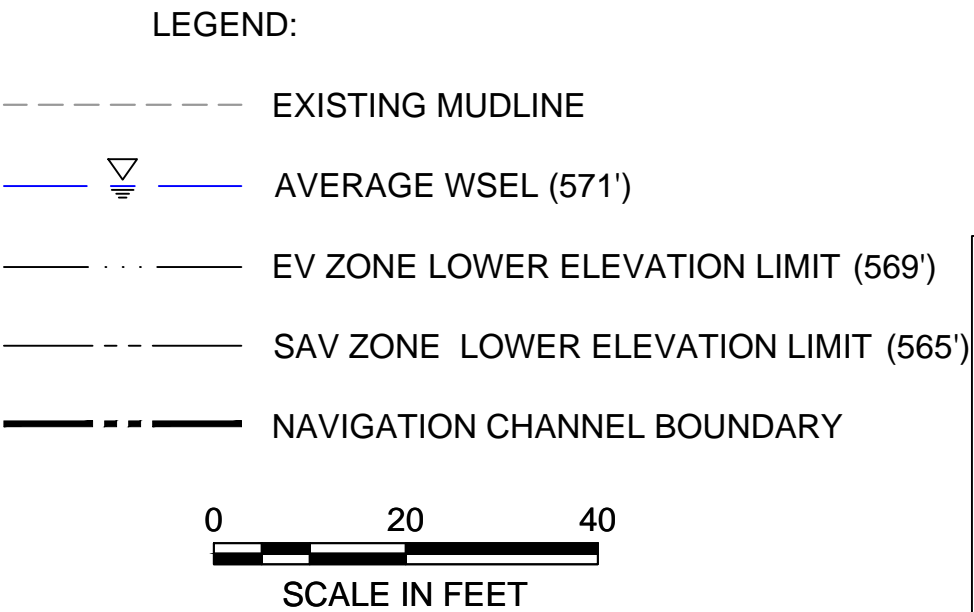
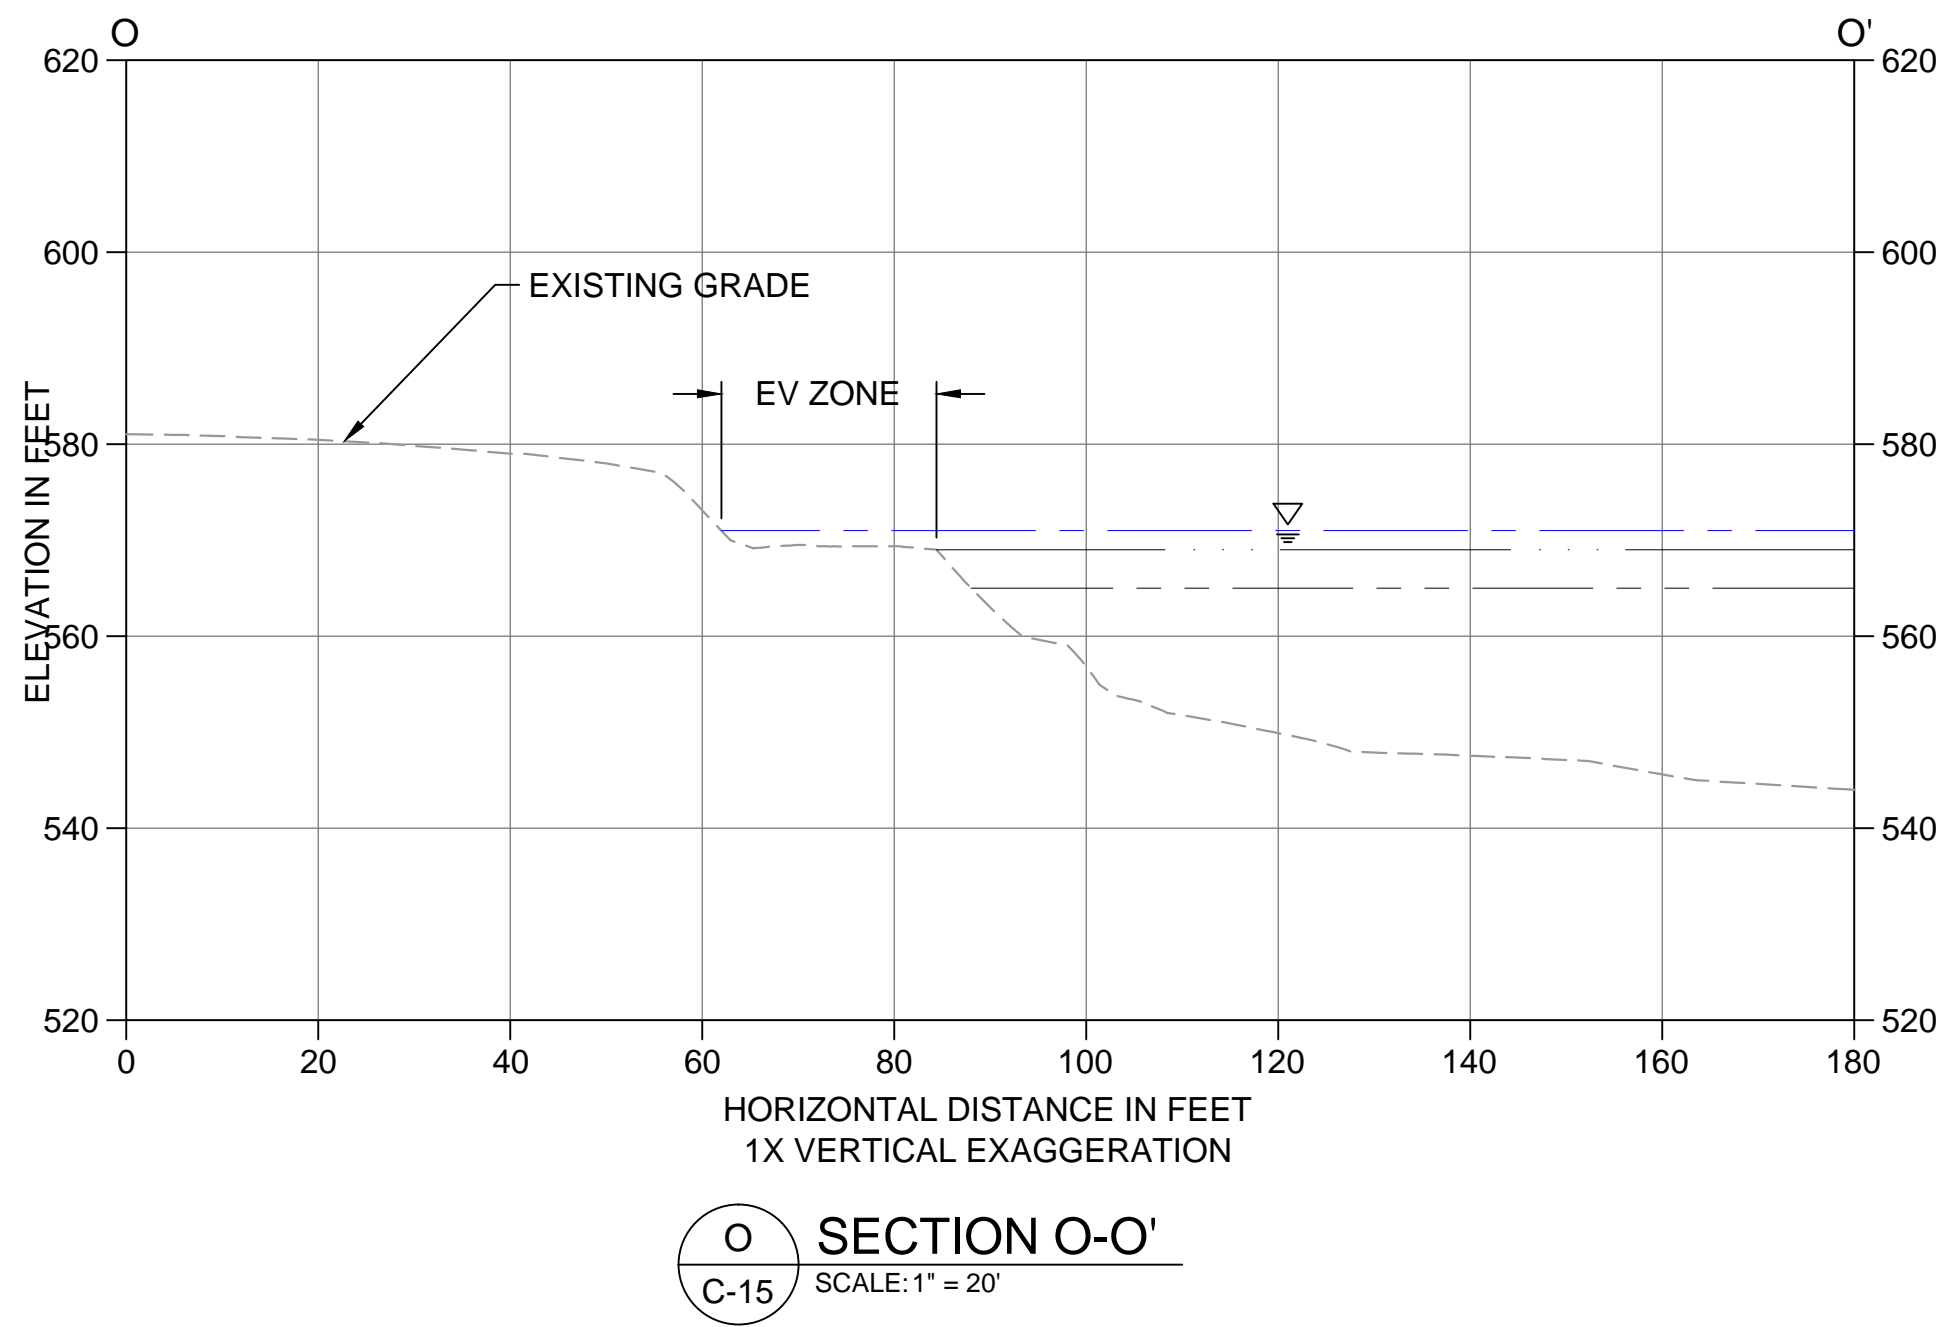
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BUFFALO RIVER AOC CAPPING AND HABITAT  
RESTORATION

CROSS-SECTIONS - OHIO STREET  
SHORELINE

C-16

SHEET NO. 19 OF 23



ONE INCH  
AT FULL SIZE, IF NOT ONE  
INCH SCALE ACCORDINGLY



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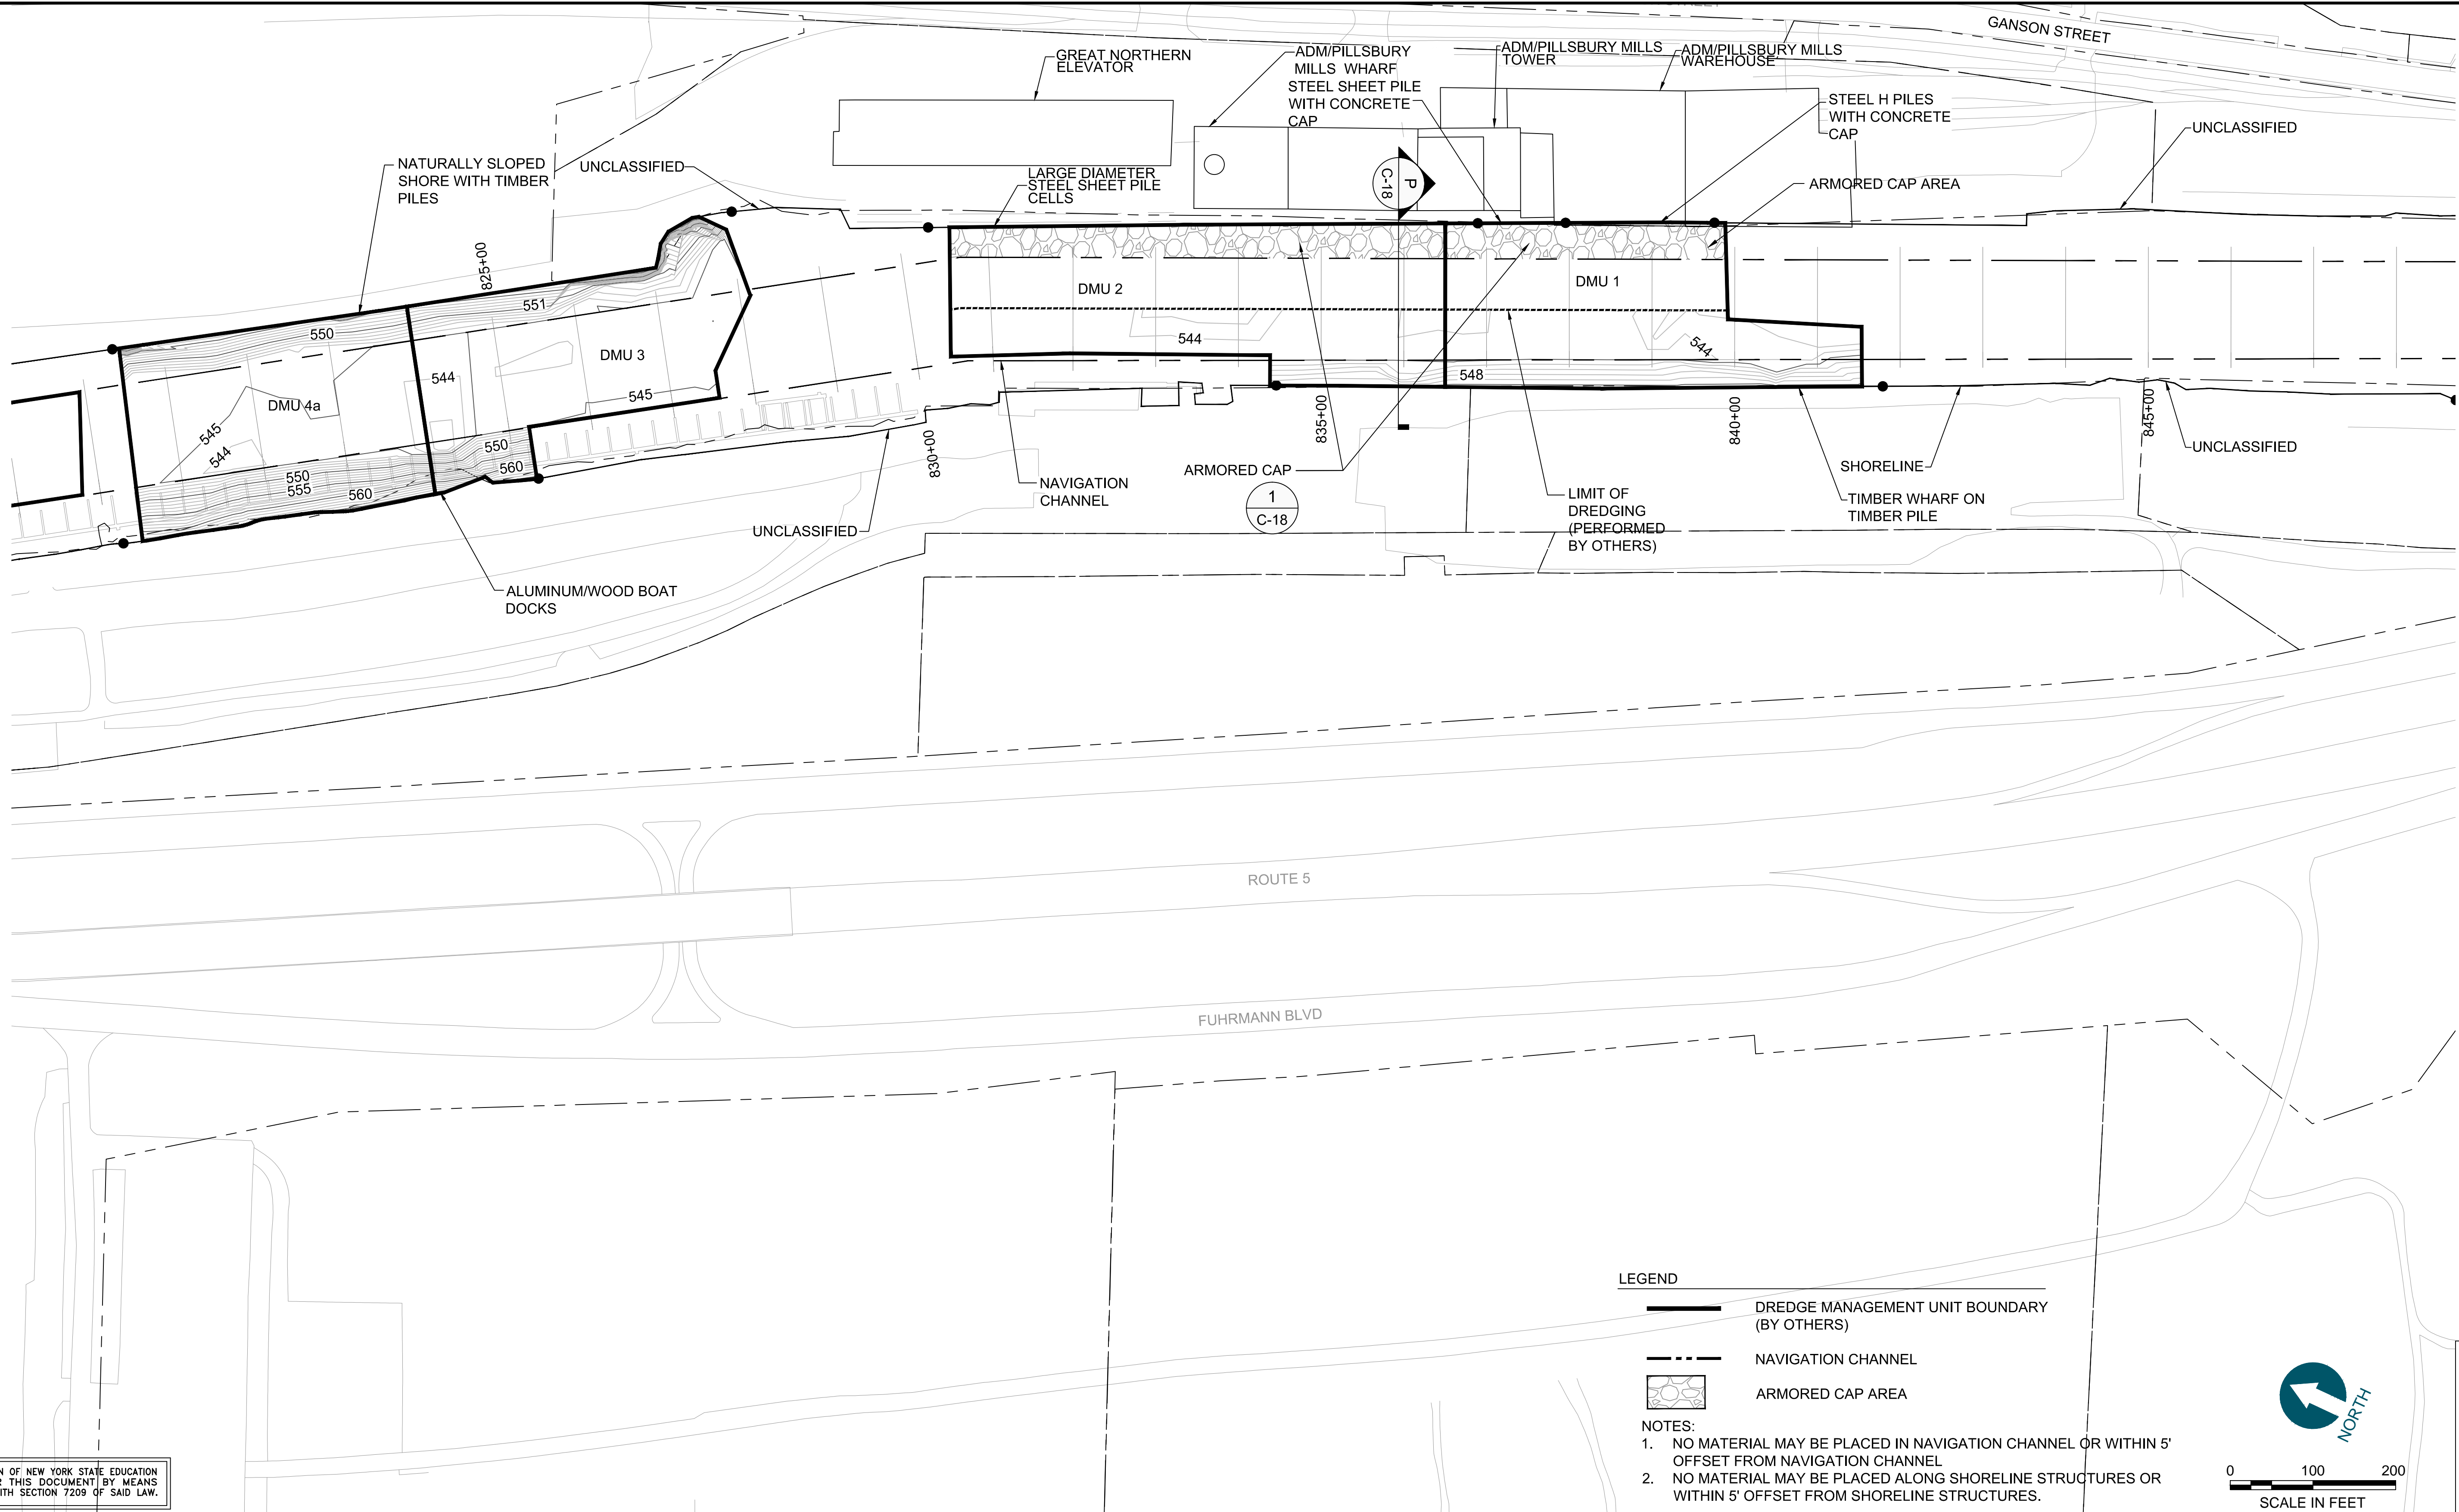
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DRAWN BY: C. HEWETT  
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APPROVED BY: P. DOODY  
DATE: MAY 2014

**BUFFALO RIVER AOC CAPPING AND HABITAT  
RESTORATION**

**CAPPING PLAN VIEW - ADM  
PILLSBURY**

**C-17**

SHEET NO. 20 OF 23





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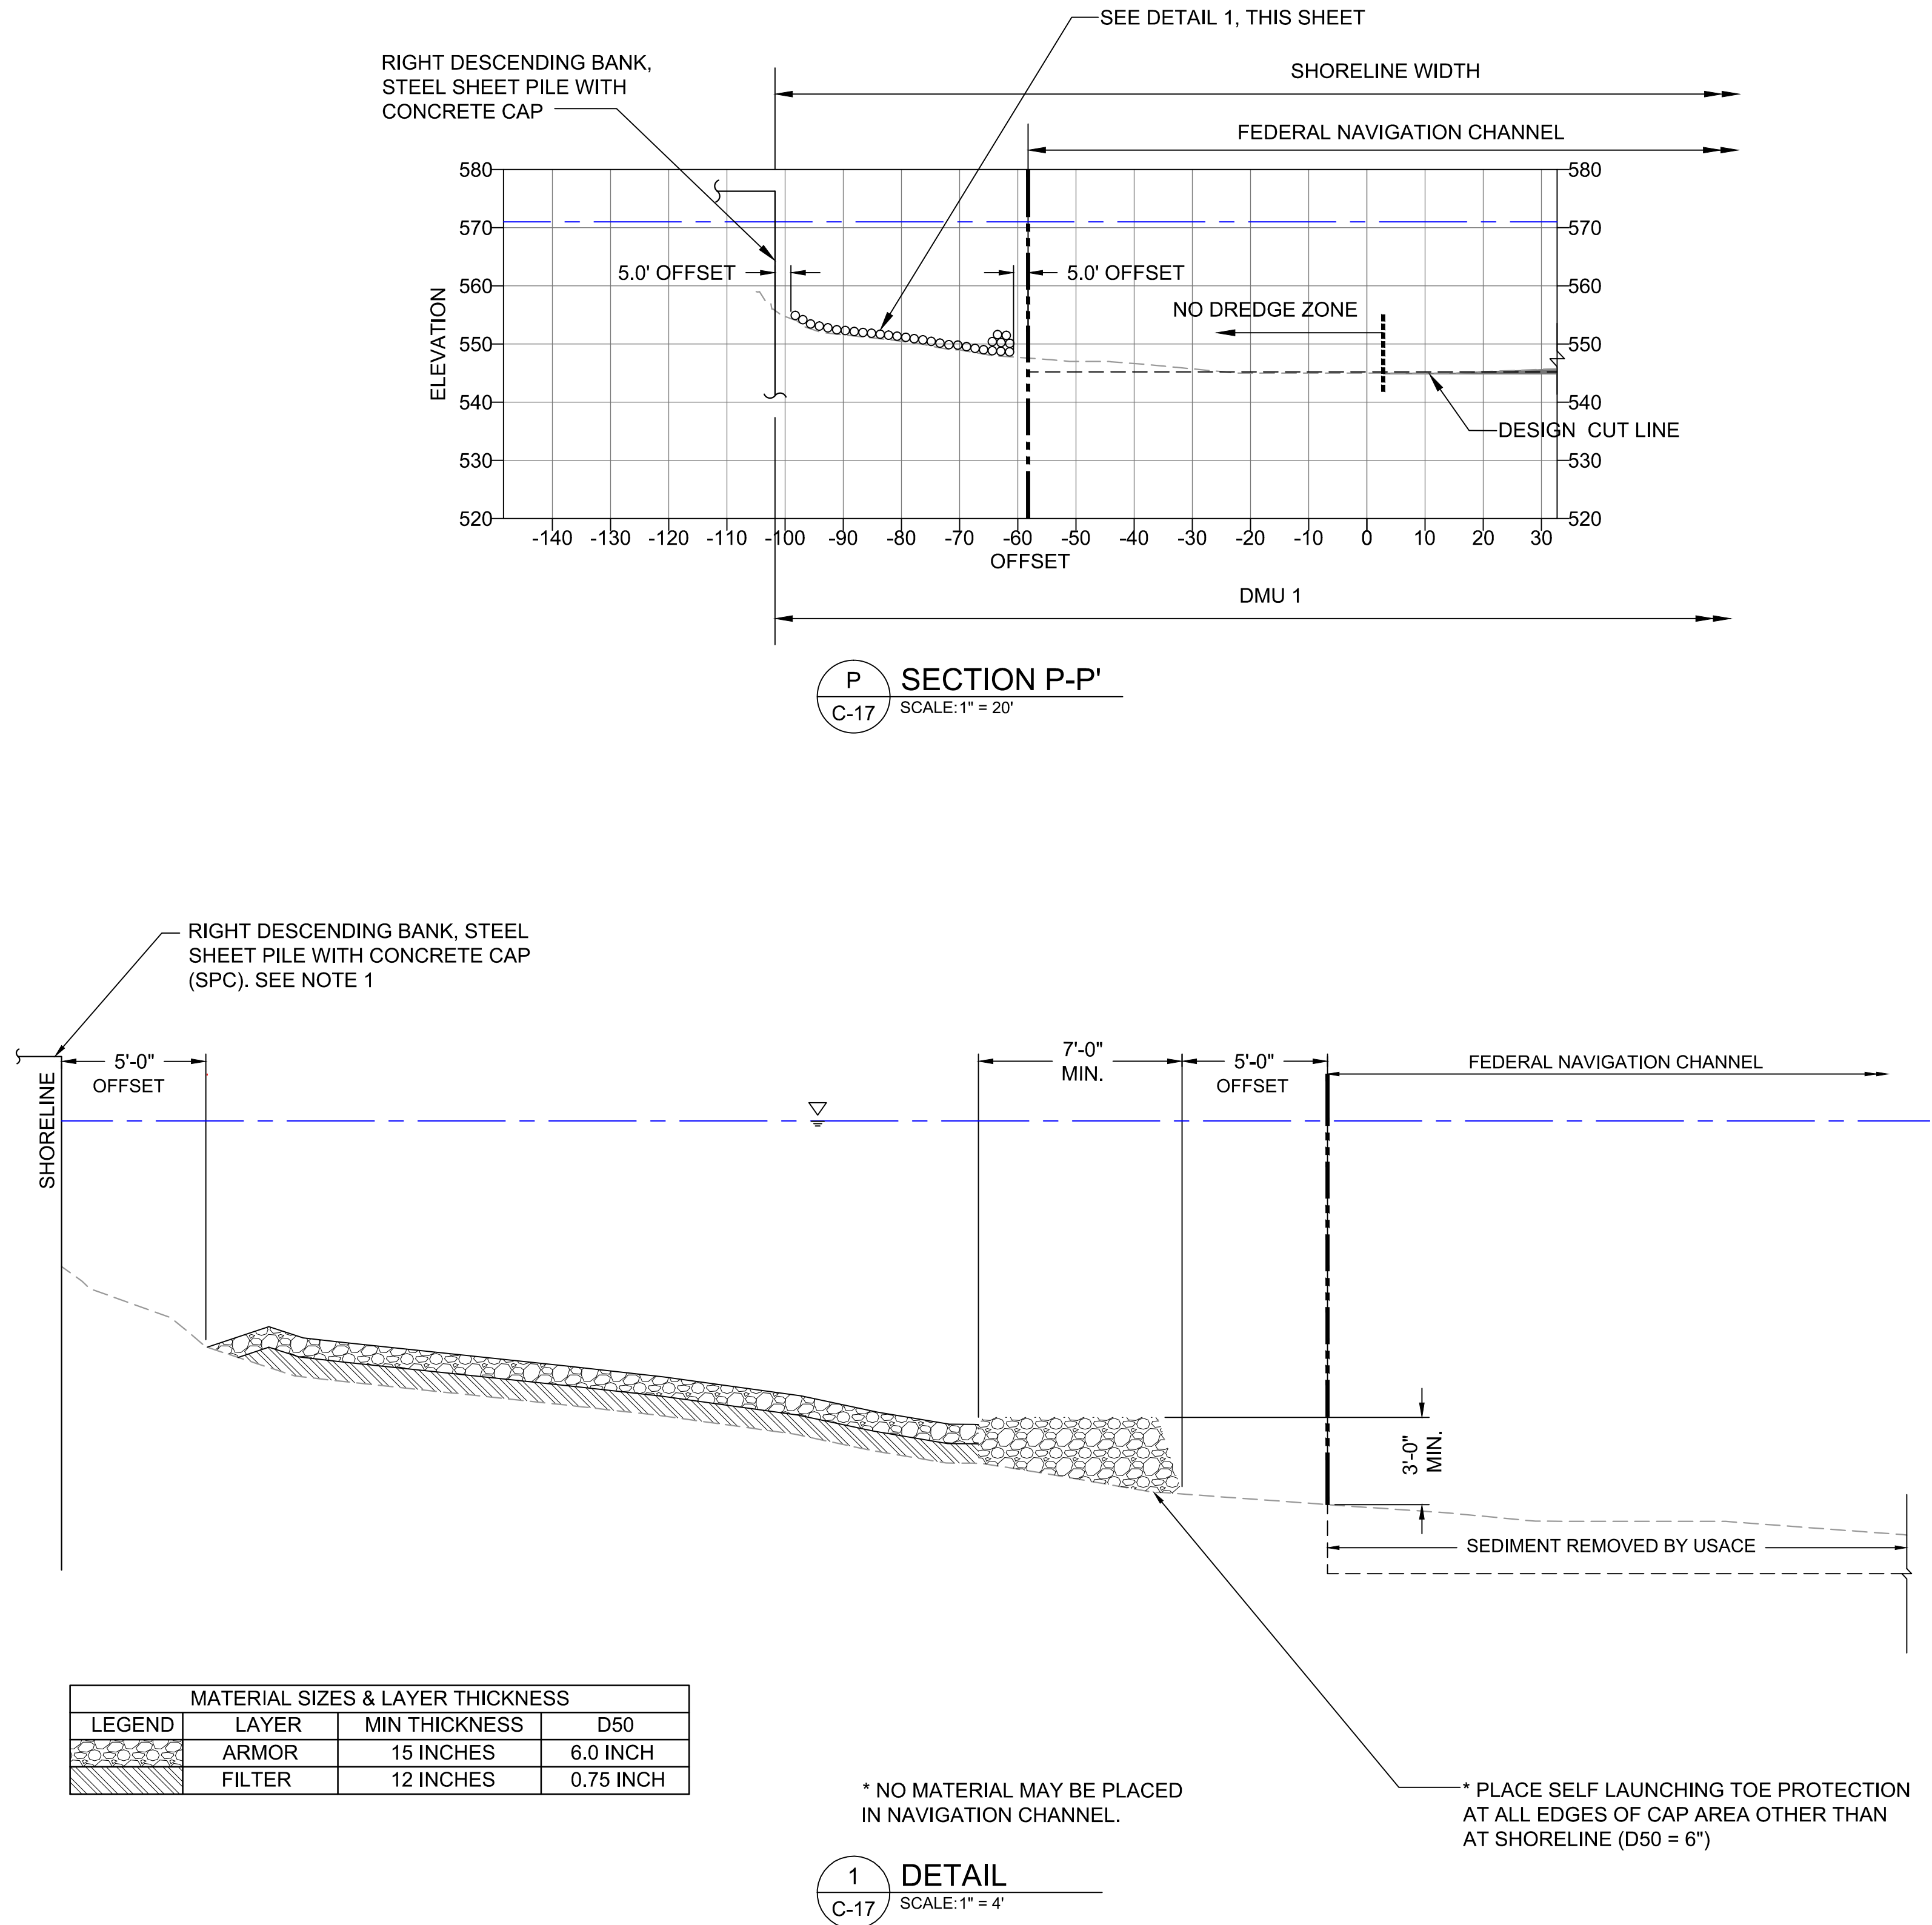
DESIGNED BY: M. HENDERSON  
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APPROVED BY: P. DOODY  
DATE: MAY 2014

**BUFFALO RIVER AOC CAPPING AND HABITAT  
RESTORATION**

**CROSS-SECTIONS - ADM PILLSBURY**



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**C-18**






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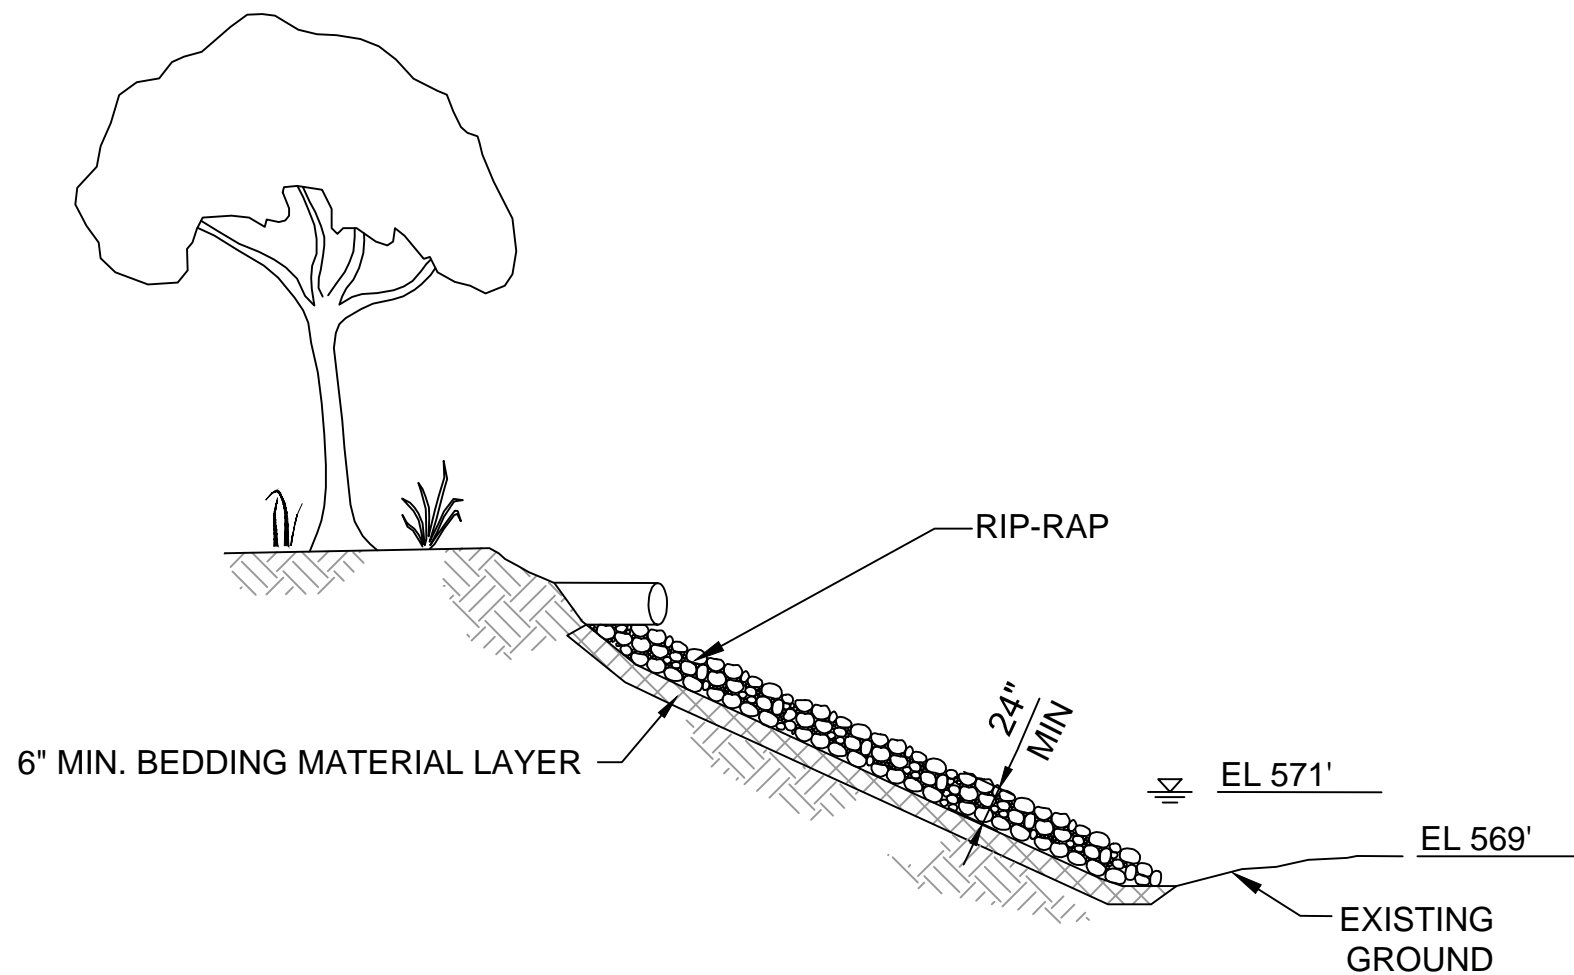


**A** COIR BANK BUFFER CROSS-SECTION  
SCALE: NOT TO SCALE

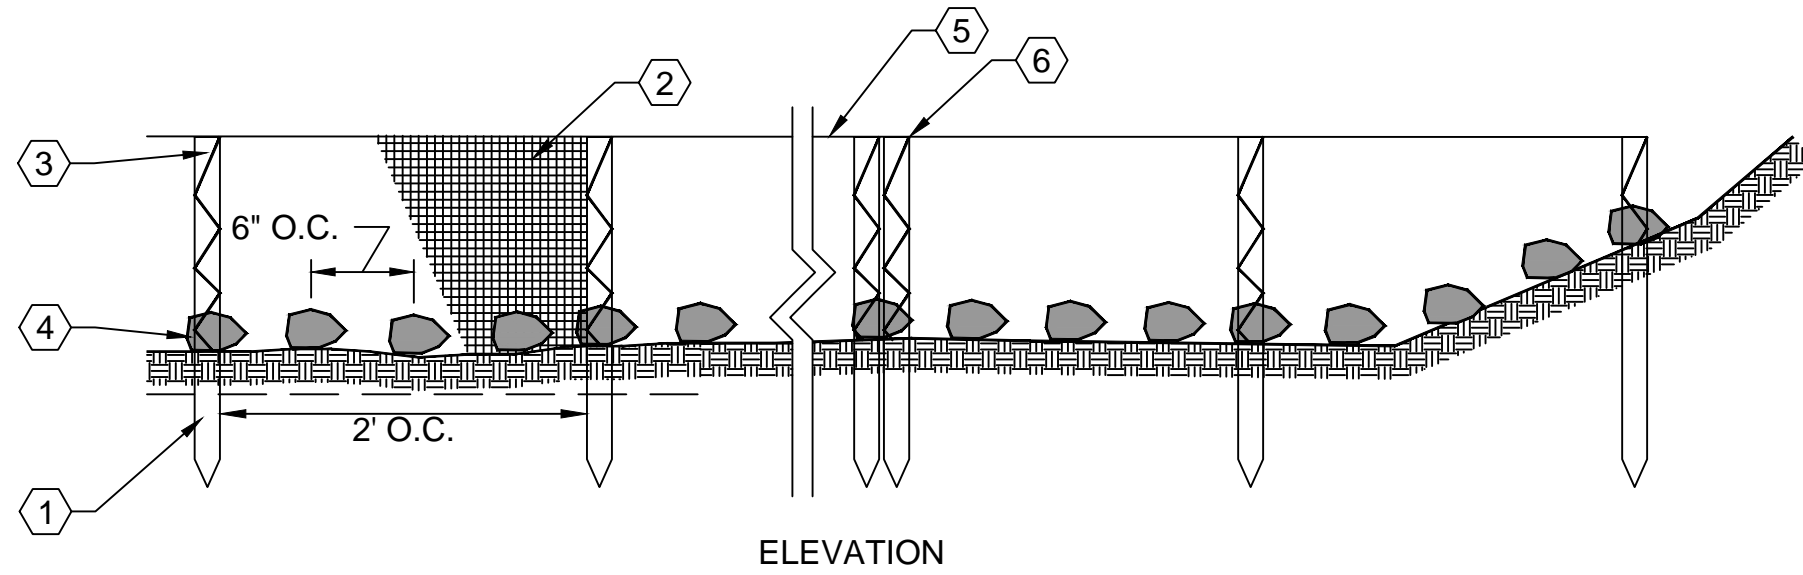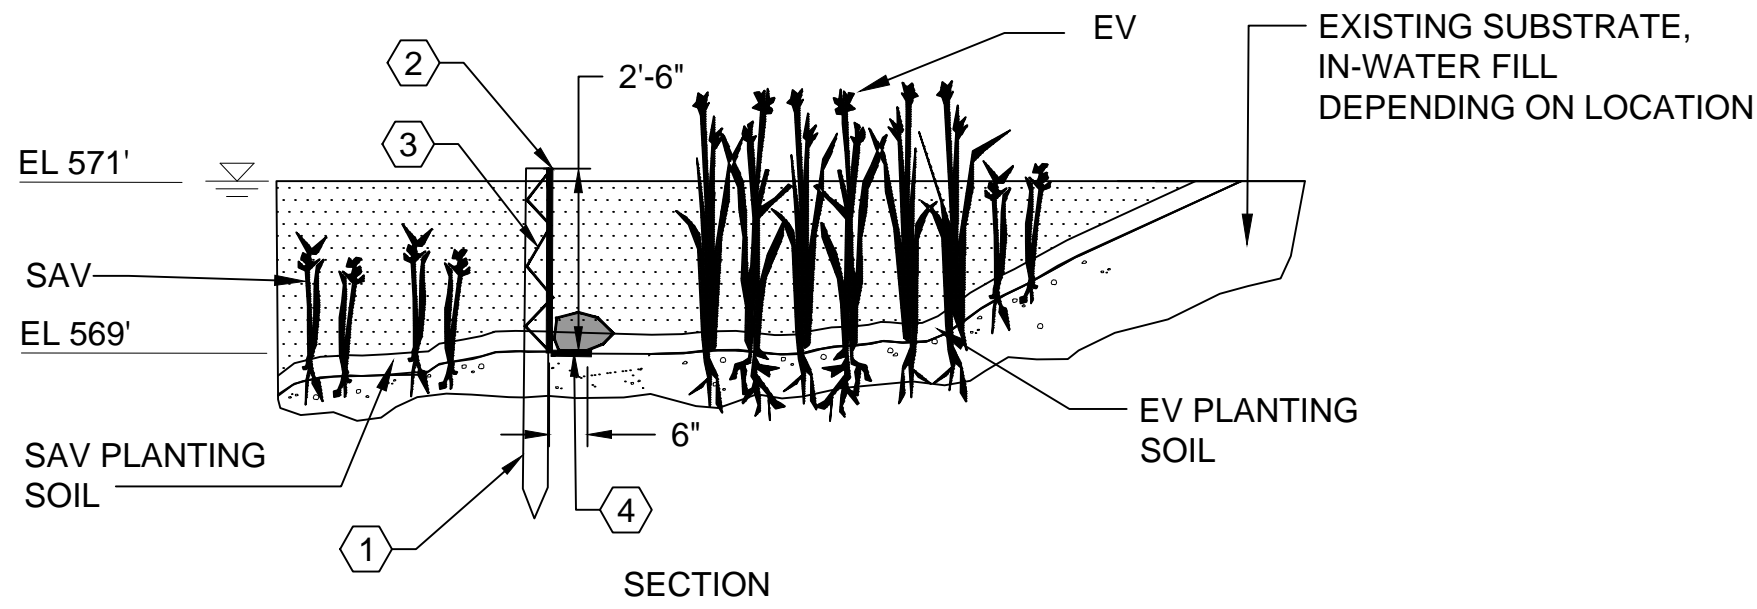- NOTES:
- WOOD STAKES
    - 2" X 2" X 60" LONG
    - DRIVE STAKES EVERY 2' O.C. INTO SUBSTRATE AT THE LOWER MARGIN OF THE EV PLANTING AREAS
  - COIR FABRIC, SEE SPECIFICATIONS
  - LASHINGS, SEE SPECIFICATIONS
  - LAY EXCESS FABRIC UPSLOPE AT THE BOTTOM OF THE FENCE AND COVER WITH STONES PLACED EVERY 6 INCHES ON CENTER, SEE SPECIFICATIONS.
  - PATTERN REPEATS IN 10' LONG SEGMENTS.
  - DO NOT JOIN OR LASH SEGMENTS TOGETHER. START A NEW SEGMENT BY DRIVING THE FIRST STAKE IN THE NEW SEGMENT SO IT TOUCHES THE END STAKE FOR THE PREVIOUS, ADJACENT SEGMENT.
  - TIE COIR BANK BUFFER INTO THE SHORE AT ENDS OF EV PLANTING AREAS.

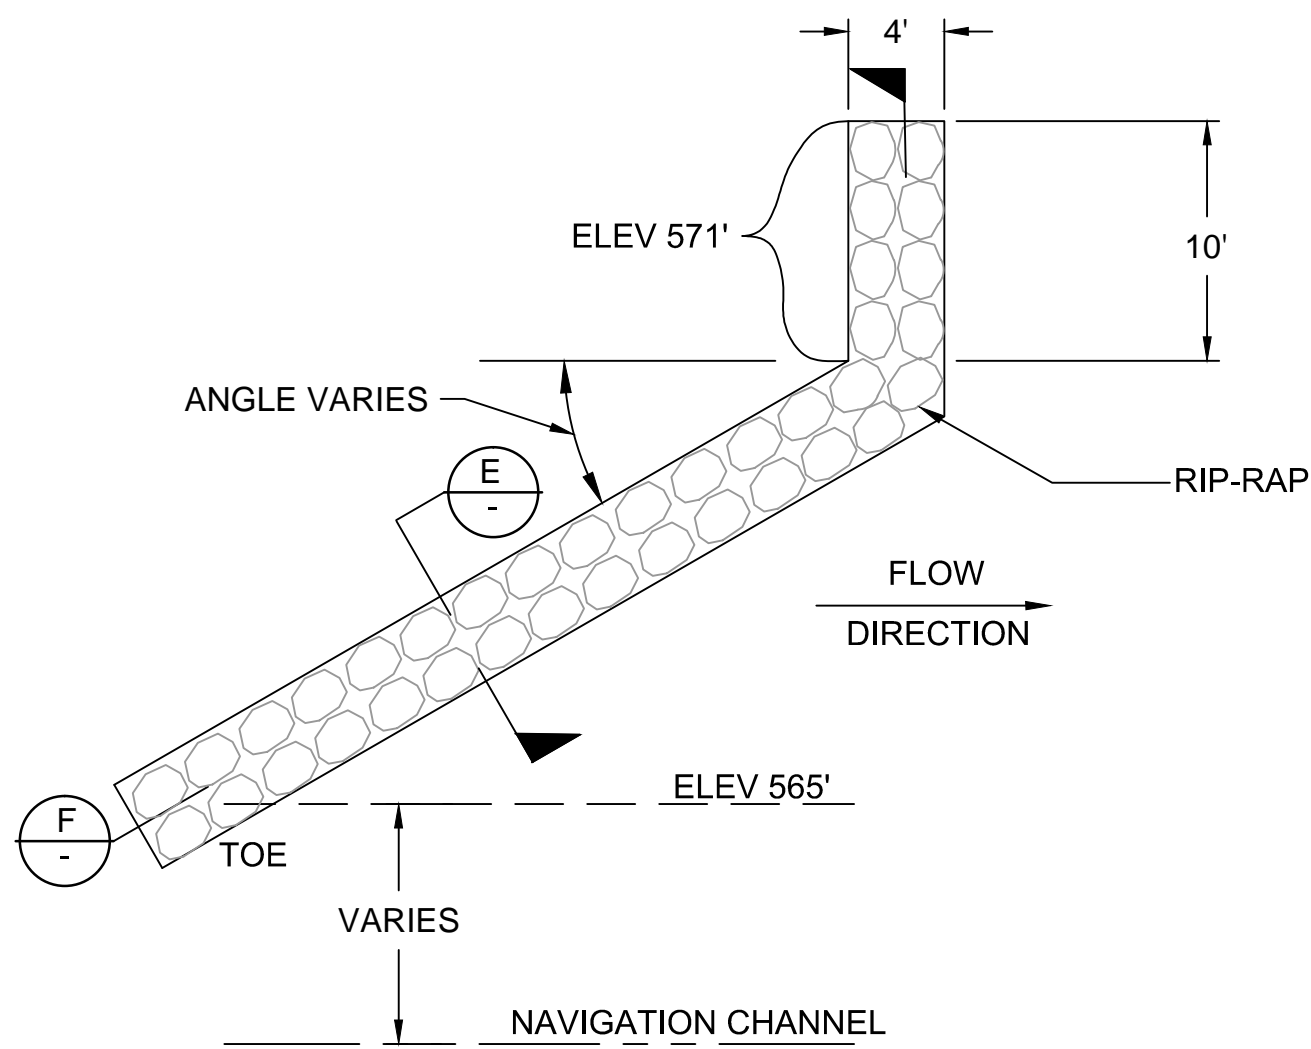


**D** ROCK VANE PLAN VIEW  
C-07 SCALE: NOT TO SCALE




**B** TYP. OUTFALL SCOUR PROTECTION  
SCALE: NOT TO SCALE

- NOTES:
- PROTECT ALL OUTFALLS DURING CONSTRUCTION.
  - ALL OUTFALLS WITHIN SAV AND EV PLANTING AREAS SHALL RECEIVE OUTFALL SCOUR PROTECTION.
  - SCOUR PROTECTION SHALL STOP AT 569' ELEVATION IN ALL CASES.
  - OUTFALL INFORMATION WAS NOT AVAILABLE FOR ALL OUTFALLS WITHIN THE RESTORATION SITES. PRIOR TO HABITAT RESTORATION ACTIVITIES, THE LOCATIONS AND SIZES SHALL BE FIELD VERIFIED.
  - MATERIAL EXCAVATED FOR PLACEMENT OF THE BEDDING MATERIAL LAYER SHALL BE SIDE CAST EVENLY ON ADJACENT SIDES OF THE OUTFALL SCOUR PROTECTION. SIDE CAST MATERIAL DEPTH SHALL NOT EXCEED 1 FOOT AS MEASURED FROM THE EXISTING GRADE. SIDE CASTING OF MATERIAL SHALL OCCUR PRIOR TO PLACEMENT OF PLANTING SUBSTRATE.

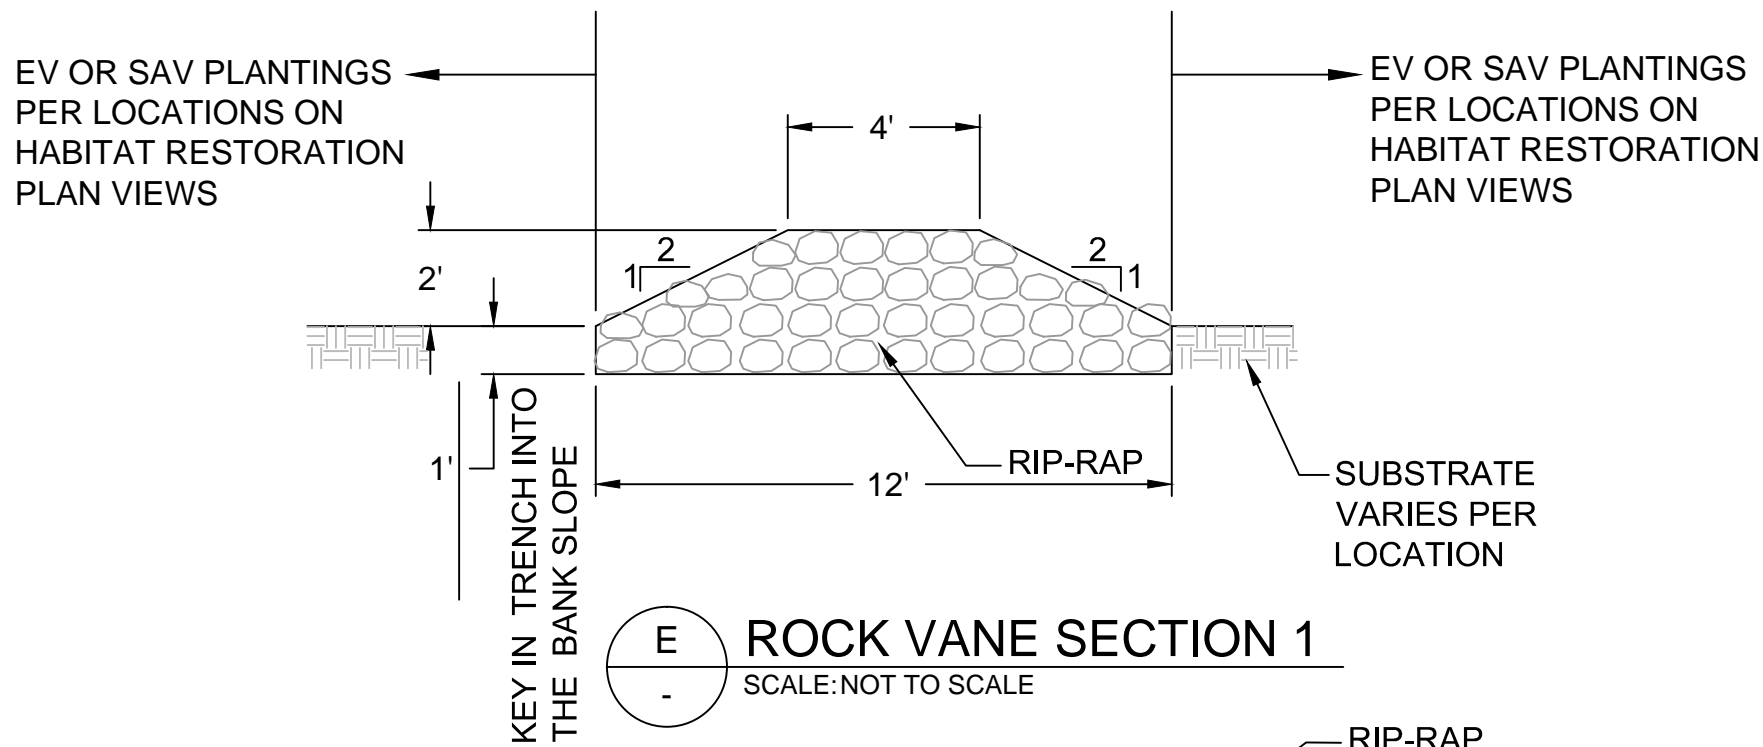

**E** ROCK VANE SECTION 1  
SCALE: NOT TO SCALE



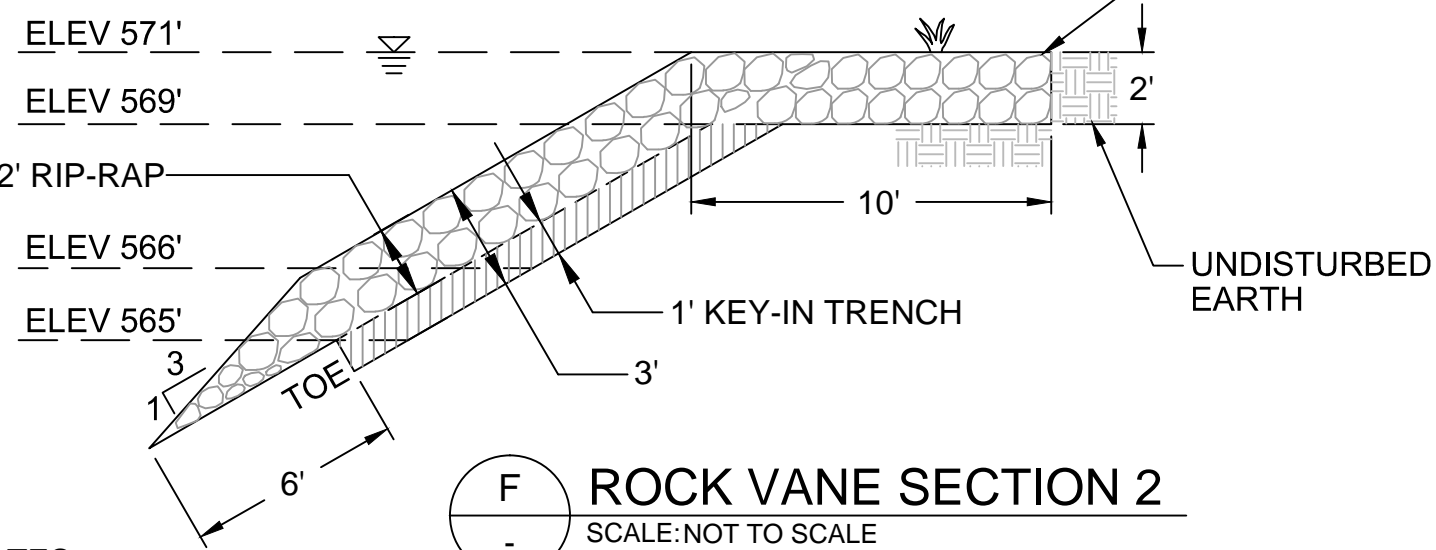


**F** ROCK VANE SECTION 2  
SCALE: NOT TO SCALE

- NOTES:
- MATERIAL EXCAVATED FOR PLACEMENT OF THE ROCK VANES SHALL BE SIDE CAST ON THE UPSTREAM SIDE OF THE VANES. SIDE CAST MATERIAL DEPTH SHALL NOT EXCEED 1 FOOT AS MEASURED FROM THE EXISTING GRADE. SIDE CASTING OF MATERIAL SHALL OCCUR PRIOR TO PLACEMENT OF PLANTING SUBSTRATE.



EXAMPLE COMPLETED CRIB  
(ROCK FILL NOT SHOWN)

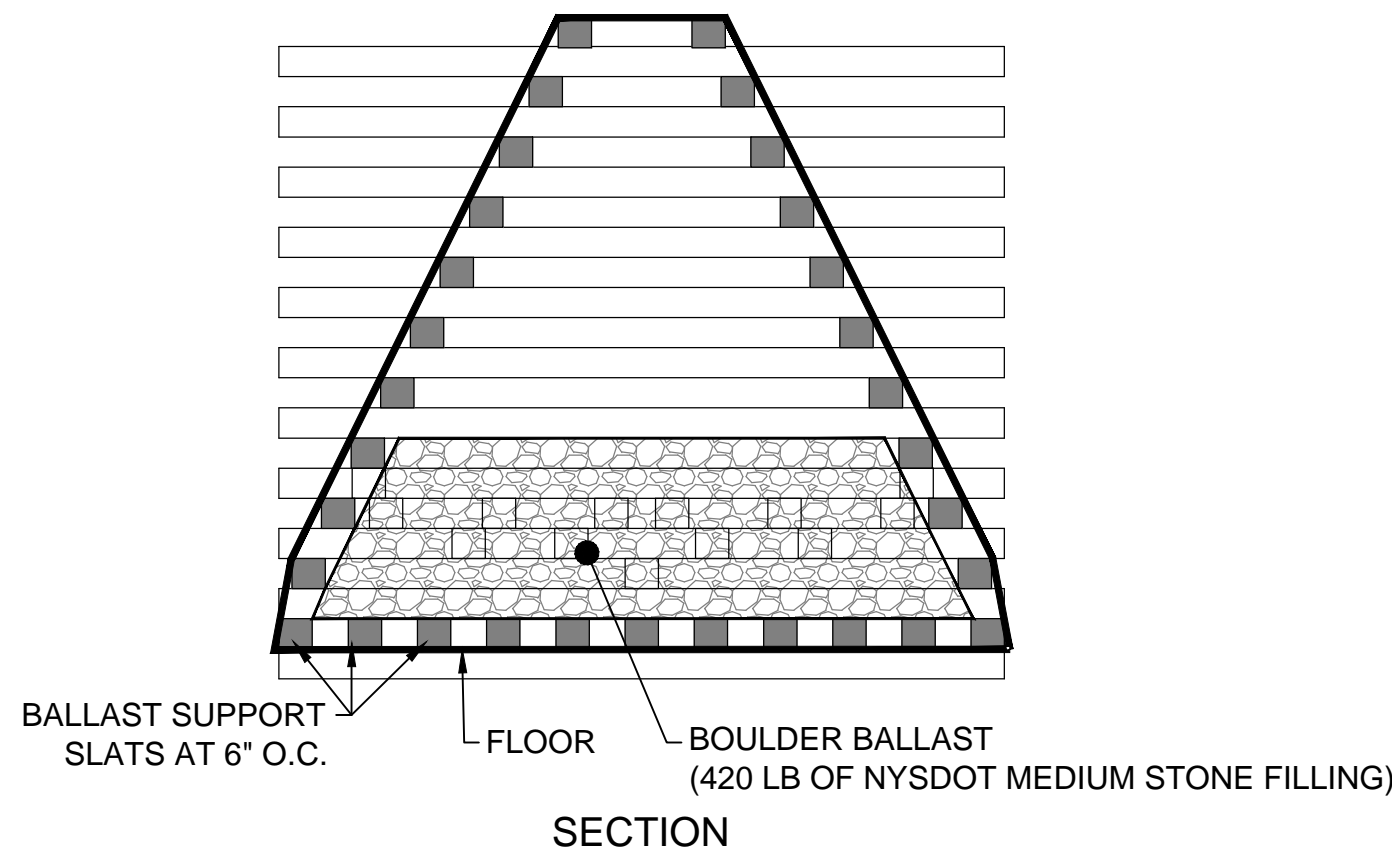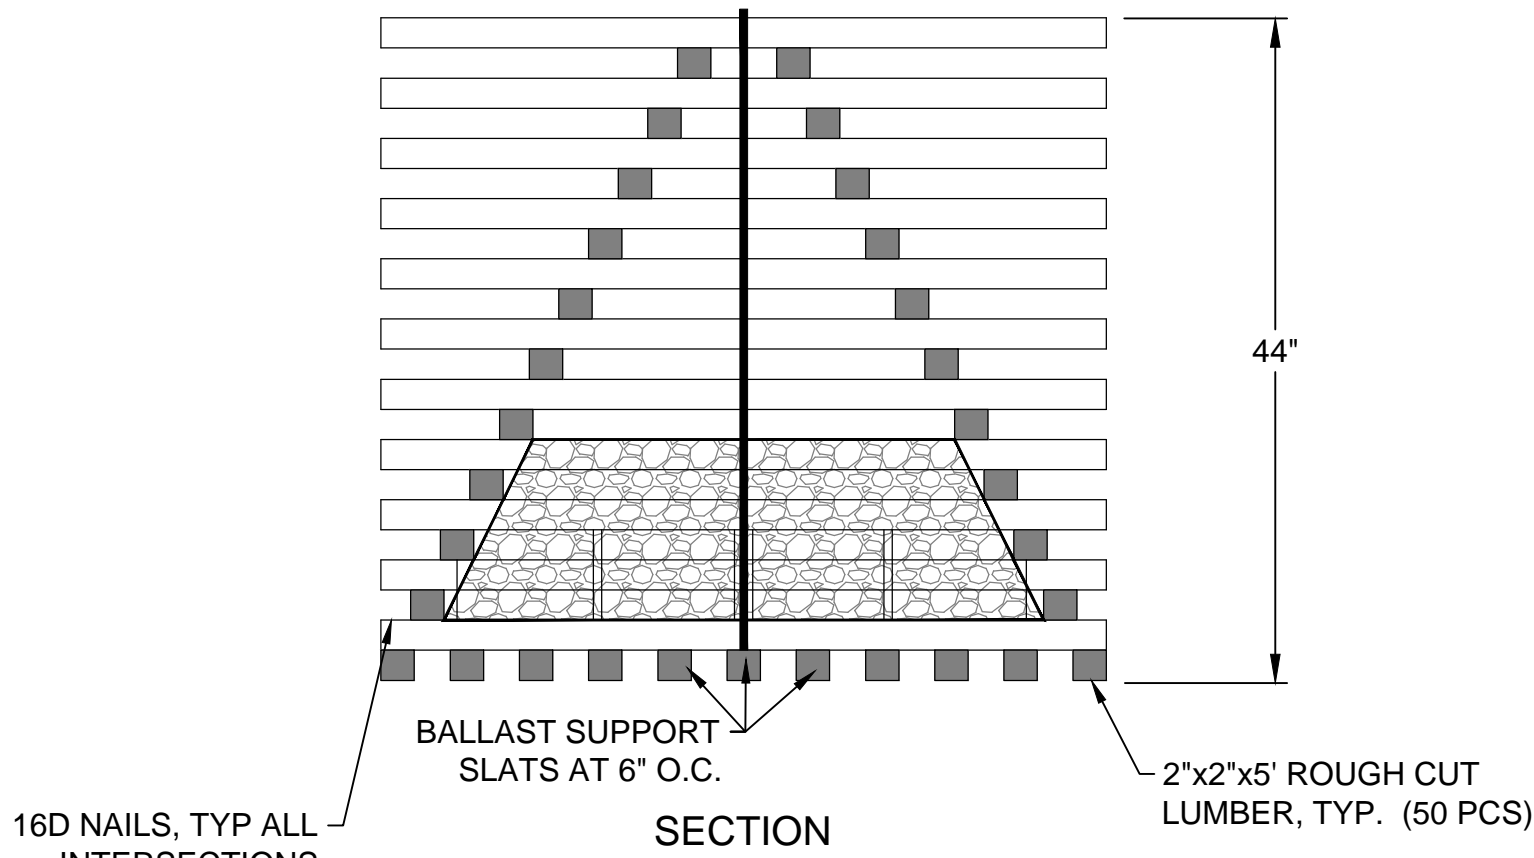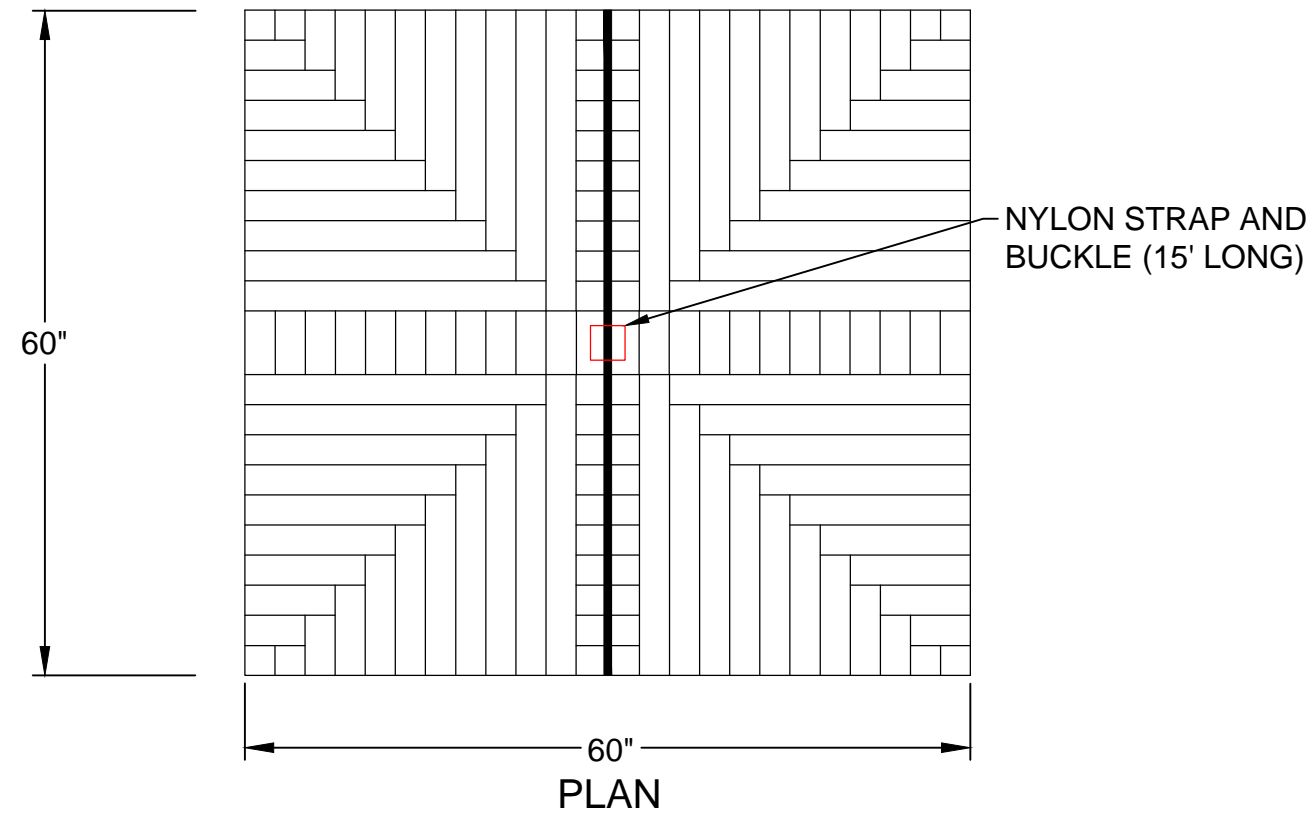

**C** TYP. PORCUPINE CRIB  
C-09 SCALE: NOT TO SCALE

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DESIGNED BY: J. GAFFNEY  
DRAWN BY: J. GAFFNEY/C. HEWETT  
CHECKED BY: M. REEMTS  
APPROVED BY: P. DOODY  
DATE: MAY 2014

**BUFFALO RIVER AOC CAPPING AND HABITAT RESTORATION**


**HABITAT RESTORATION DETAILS (1 OF 2)**

**C-19**

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ONE INCH  
AT FULL SIZE, IF NOT ONE  
INCH SCALE ACCORDINGLY




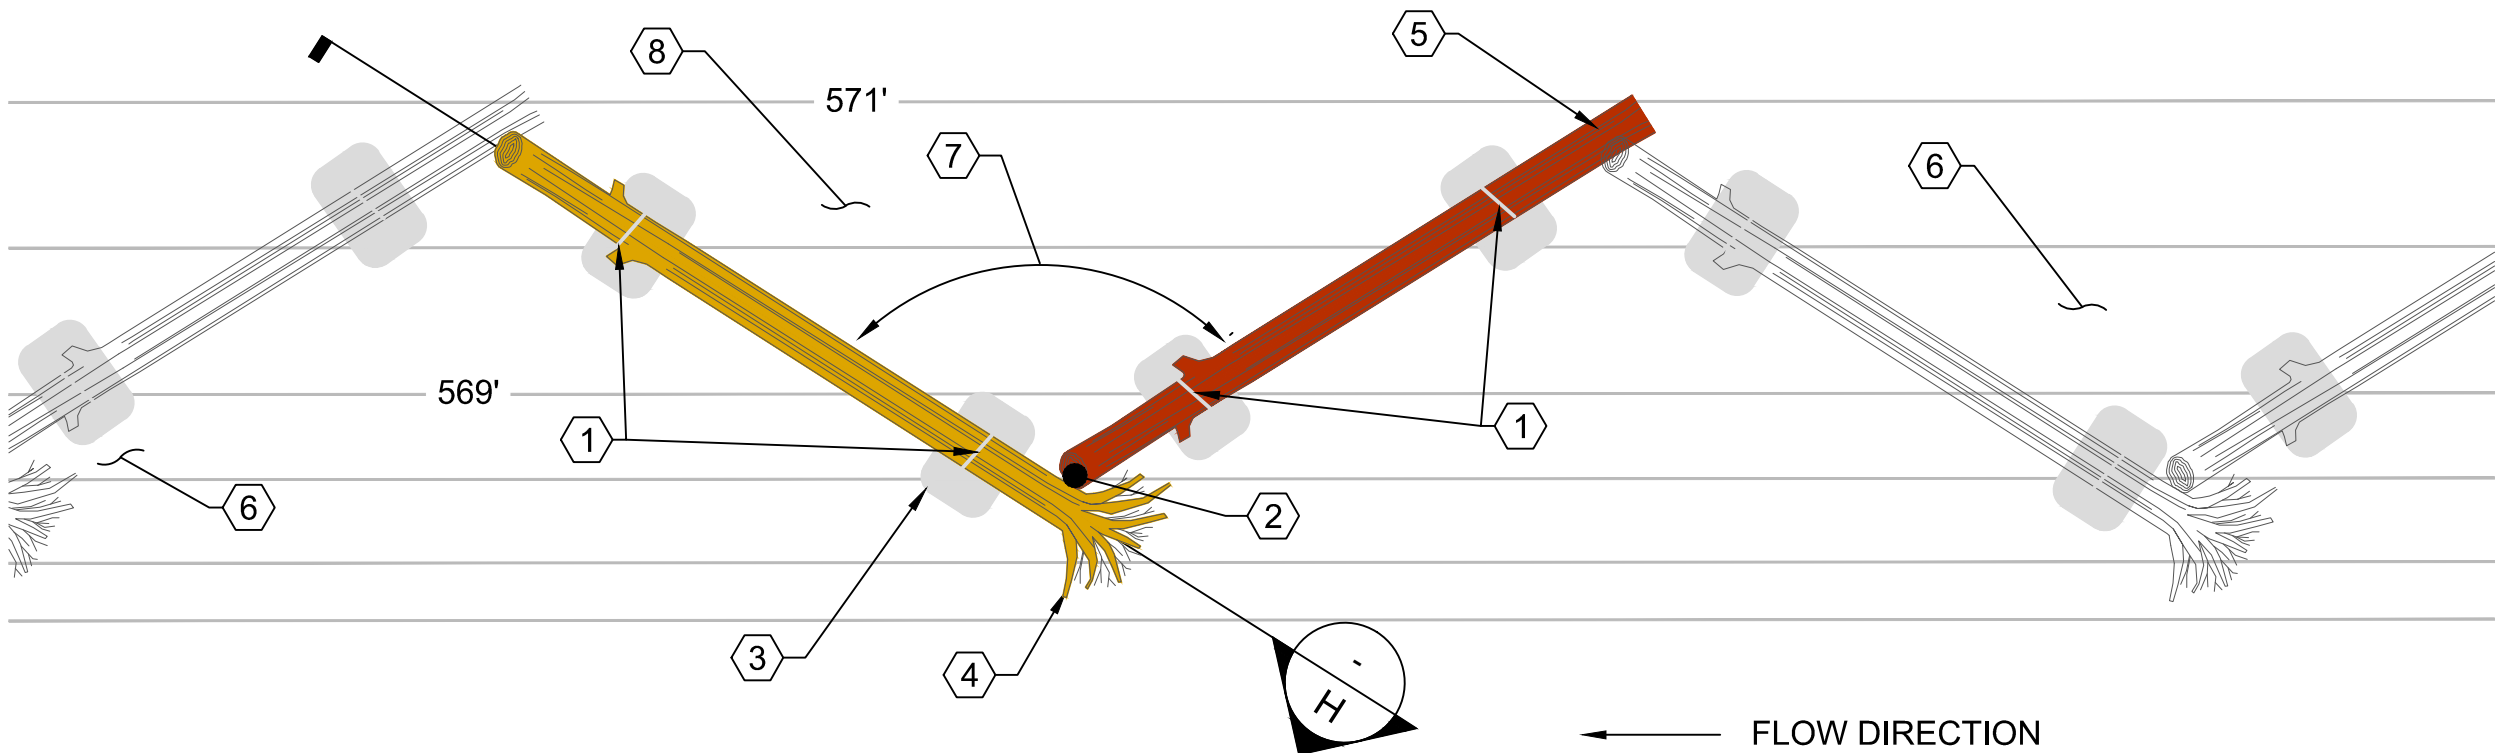


**G BANK ROOTWAD CHAIN DETAIL**  
C-07 SCALE: NOT TO SCALE

**NOTES:**

- CONNECT LOGS AND ROOTWAD LOGS TO NATURAL STONE BLOCKS AT LOCATIONS SHOWN PER BLOCK CONNECTION DETAIL.
- BUTT ROOTWAD LOGS AND LOGS TOGETHER AT LOCATIONS SHOWN
- STONE BLOCKS
  - MIN. DRY WEIGHT OF 5,500 LB.
  - NO MORE THAN 2.0' THICK.
  - SEE SPECIFICATIONS FOR ADDITIONAL REQUIREMENTS.
- ROOTWADS
  - DIMENSIONS: BOLE (TRUNK); 2-FOOT DIAMETER AT BREAST HEIGHT, 35-FOOT LONG (MIN.). ROOTWAD; 6-FOOT DIAMETER AT A DISTANCE OF 4-FEET FROM THE START OF THE ROOTWAD FLARE.
  - SEE SPECIFICATIONS FOR ADDITIONAL REQUIREMENTS.
- LOG POLES
  - DIMENSIONS: 2-FOOT DIAMETER AT BREAST HEIGHT, 35-FOOT LONG (MIN.).
  - PLACED TAPERED END BANKWARD.
- REPEAT PATTERN AS SHOWN ON THE PLANS.
- ANGLE VARIES AS SHOWN ON THE PLANS.
- PLANT PROTECTED AREA AS SHOWN ON THE PLANS.
- FINISHED GRADE AS SHOWN ON THE PLANS.
- ALLOW BLOCKS TO SETTLE BELOW GRADE.

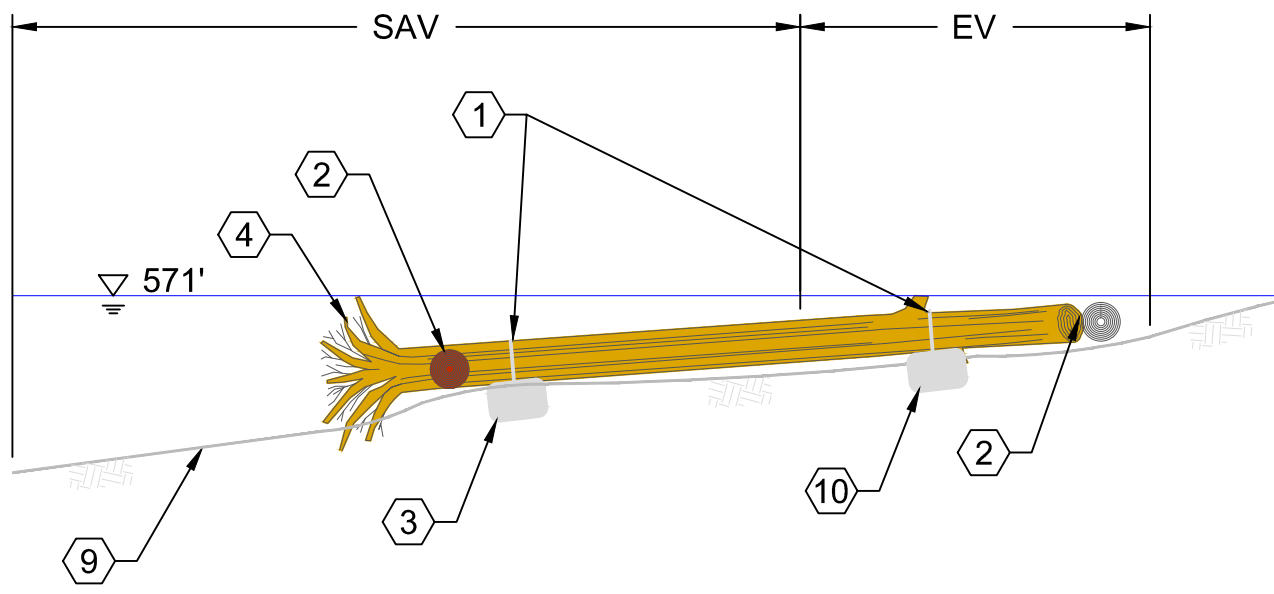


**H BANK ROOTWAD CHAIN SECTION**  
SCALE: NOT TO SCALE

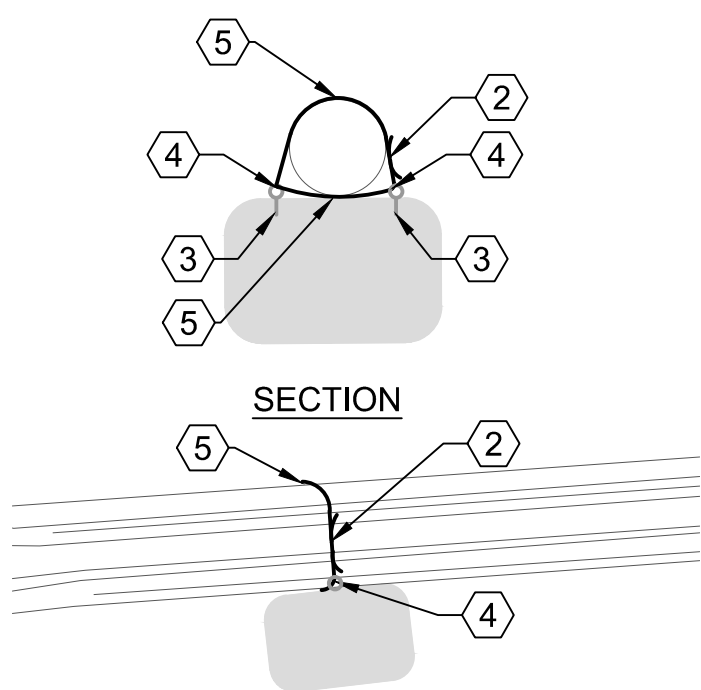


**I TYP. BLOCK CONNECTION**  
SCALE: NOT TO SCALE

**NOTES:**


- CONNECT ROOTWAD LOG TO NATURAL STONE BLOCKS AT LOCATIONS SHOWN PER BLOCK CONNECTION DETAIL.
- STONE BLOCKS
  - MIN. DRY WEIGHT OF 5,500 LB.
  - NO MORE THAN 2.0' THICK.
  - SEE SPECIFICATIONS FOR ADDITIONAL REQUIREMENTS.
- ROOTWADS
  - DIMENSIONS: BOLE (TRUNK); 2-FOOT DIAMETER AT BREAST HEIGHT, 35-FOOT LONG (MIN.). ROOTWAD; 6-FOOT DIAMETER AT A DISTANCE OF 4-FEET FROM THE START OF THE ROOTWAD FLARE.
  - SEE SPECIFICATIONS FOR ADDITIONAL REQUIREMENTS.
- ANGLE VARIES AS SHOWN ON THE PLANS.
- GRADE AS SHOWN ON THE PLANS.
- ALLOW BLOCKS TO SETTLE BELOW GRADE.

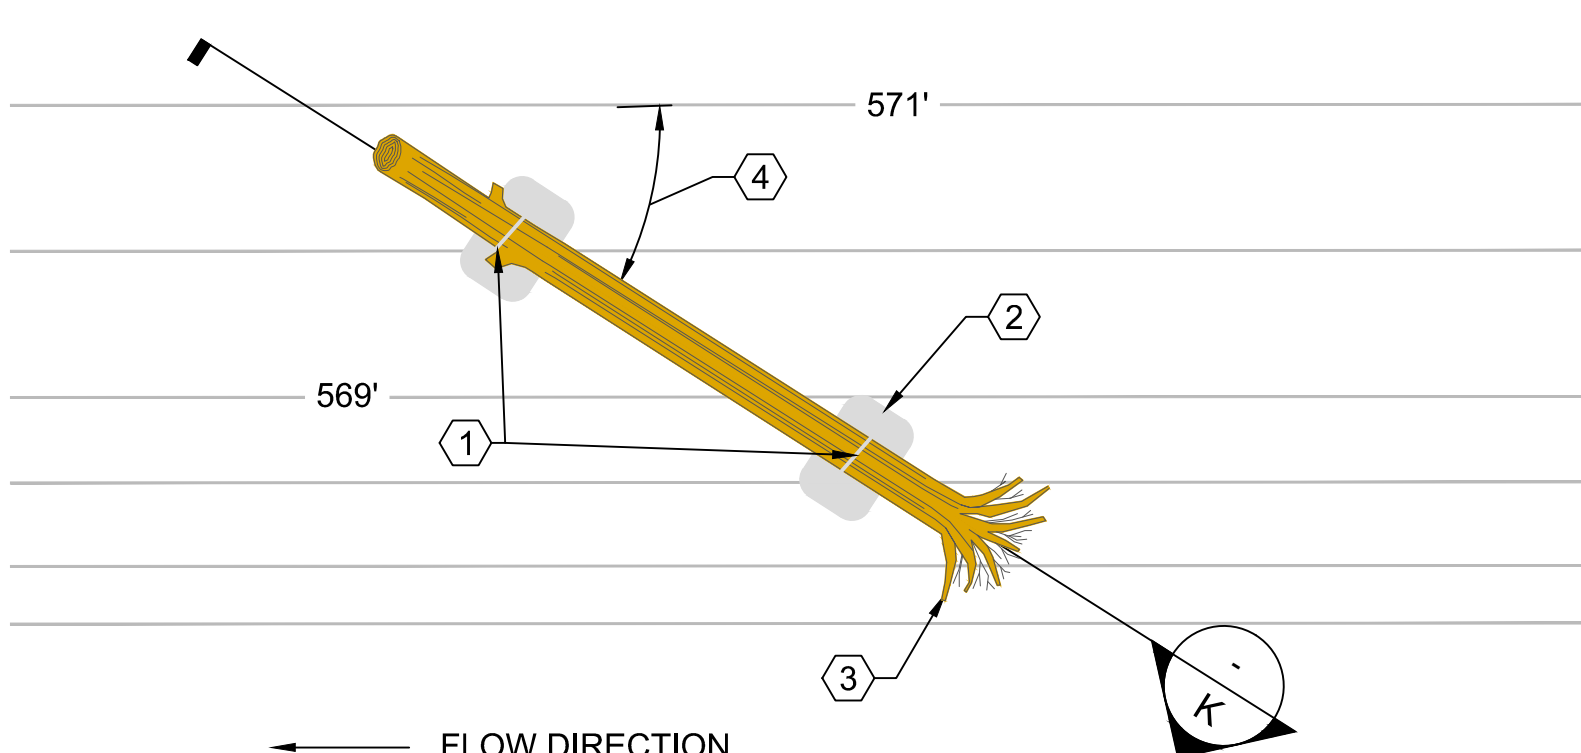

**J ANCHORED ROOTWAD DETAIL**  
C-09 SCALE: NOT TO SCALE

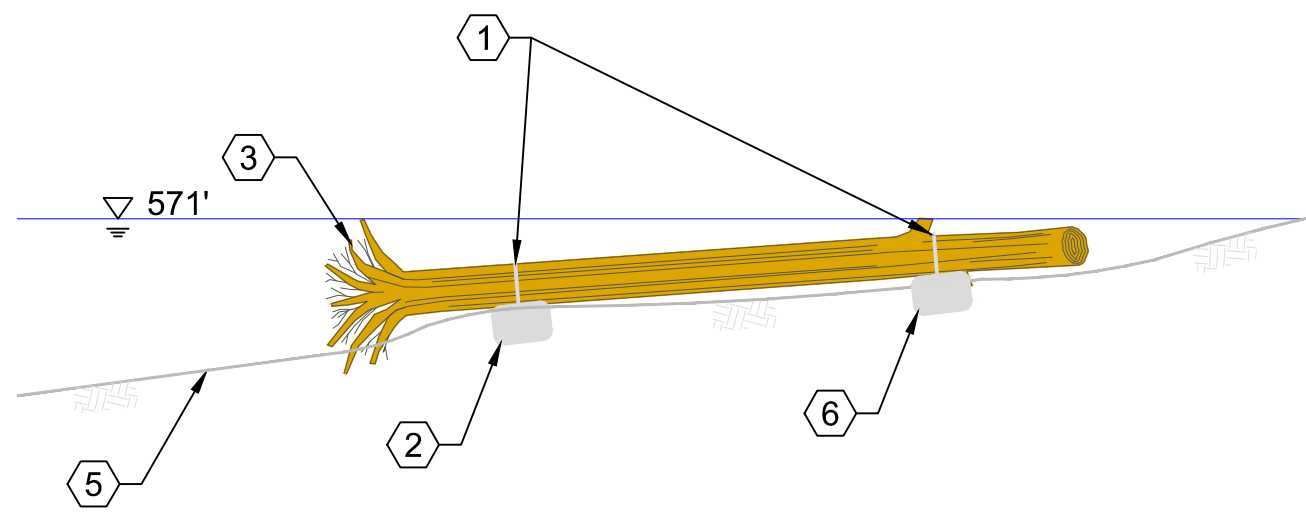

**K ANCHORED ROOTWAD SECTION**  
SCALE: NOT TO SCALE

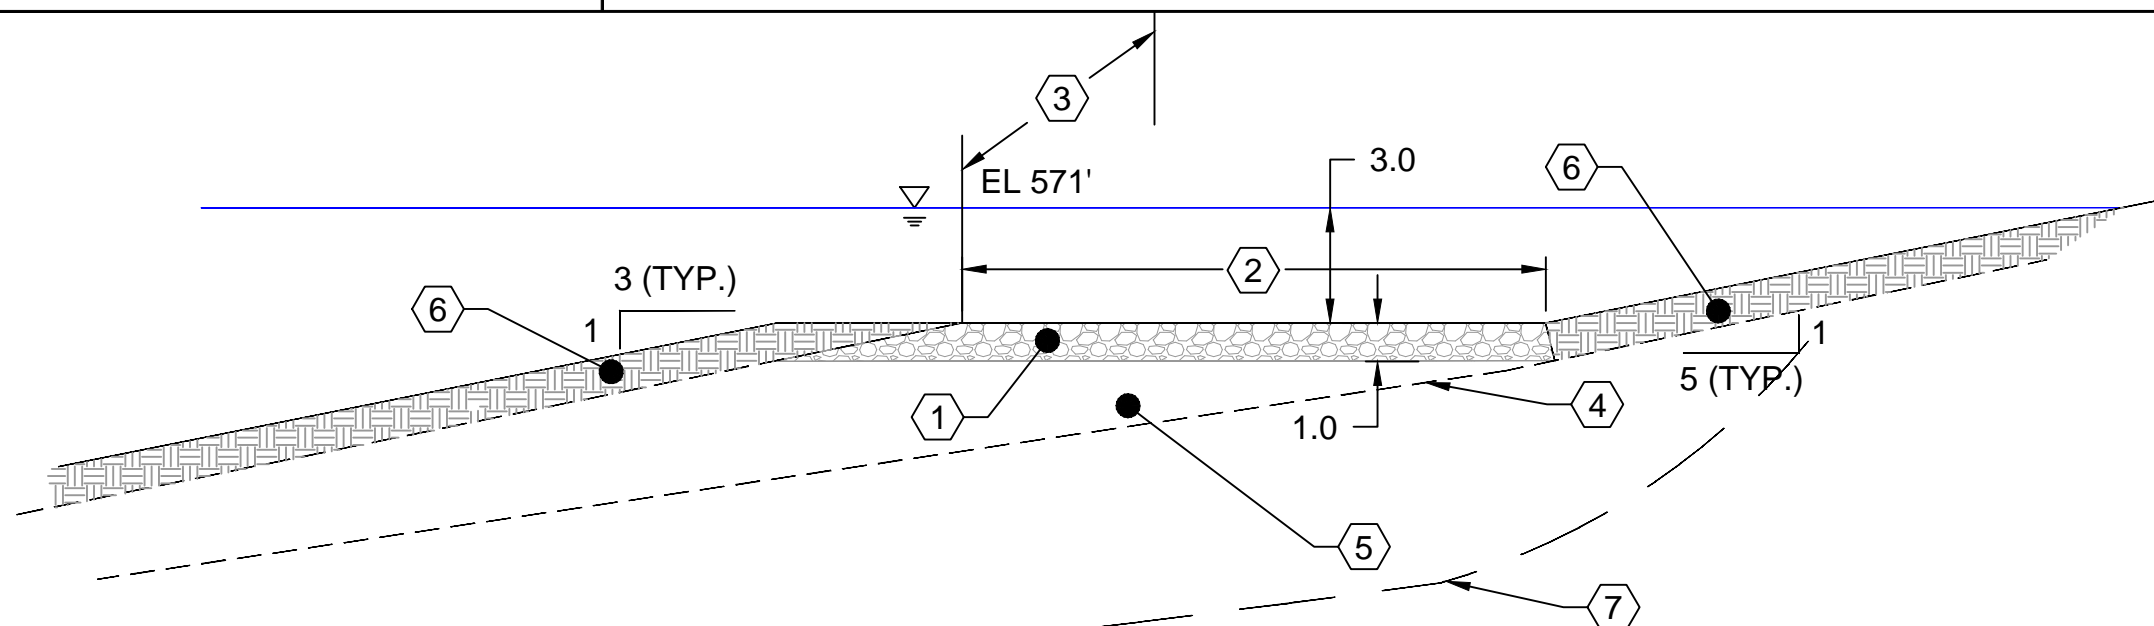

**L GRAVEL SPAWNING BEDS**  
C-09 SCALE: NOT TO SCALE

**NOTES:**

- FISH GRAVEL MATERIAL: SEE SPECIFICATIONS.
- GRAVEL BENCHES MAY VARY IN WIDTH FROM 10 TO 25 FEET. WIDTH MAY VARY ALONG THE LENGTH SO LONG AS THE MINIMUM COVERAGE AREA IS MET.
- GRAVEL BENCHES MAY VARY IN LENGTH FROM 100 TO 250 FEET.
- IN-WATER FILL SUBGRADE SURFACE IN ADJACENT SAV AREA VARIES, SEE BACKFILL PLAN ON C-09.
- IN-WATER FILL.
- PLANTING SOIL, SEE SPECIFICATIONS.
- CAP AS-BUILT SURFACE VARIES.

IT IS A VIOLATION OF NEW YORK STATE EDUCATION LAW TO ALTER THIS DOCUMENT BY MEANS INCONSISTENT WITH SECTION 7209 OF SAID LAW.



**DRAFT**  
**NOT FOR CONSTRUCTION**

REVISIONS					DESCRIPTION
REV	DATE	BY	APP'D		

DESIGNED BY: J. GAFFNEY  
DRAWN BY: J. GAFFNEY/C. HEWETT  
CHECKED BY: M. REEMTS  
APPROVED BY: P. DOODY  
DATE: MAY 2014

**BUFFALO RIVER AOC CAPPING AND HABITAT RESTORATION**

**HABITAT RESTORATION DETAILS (2 OF 2)**

**C-20**

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